LORD HOWE ISLAND BOARD

Development Application

Section 4.12, Environmental Planning and Assessment Act 1979

Dat	e Re	ceiv	ed:	
	-			
•••••	•••••	•••••	•••••	•••••

Use this form to apply for development consent to:

Development Application No.:

- Erect, alter or demolish a building or structure;
- Change the use of land or a building;
- Subdivide land;

- Display an advertisement;
- Any other development that requires consent from the Lord Howe Island Board.

To minimise delay in receiving a decision about your application, please ensure you submit all relevant information. To complete

assessed, you will receive a Notice of Determination. If you need help please phone or call the Board's office and discuss your
queries with a development officer.
APPLICANT DETAILS
Mr Mrs Ms Other:
Name: JOSHUA ROYLANCE ONENS
Organisation: ABN:
Postal Address:
Telephone:
Email:
OWNER CONSENT
Has Owner Consent been issued? Yes No Owner Consent No.:
IDENTIFY THE LAND YOU PROPOSE TO DEVELOP
Portion/Lot No.: DP 120 Z 580
Lease No.: 2015.01 (4152)
Address:

PROPOSED DEVELOPMENT

Describe the proposed development; give a detailed outline of what you are going to do. If it involves a building, indicated what it will be used for.

Relocation of wastewater irrigation field for existing wastewater system, and

Extension onto existing dwelling which will be store plumbing material. An existing old shed with be removed

Building Material: Weatherboard fibro

Roofing Material: Colorbond custom orb

Lord Howe Island Board

Development Application

Version December 2020

Page 1 of 4

	-	
		1
		1
••••••	•••••	
na		
ne.	6.7	
	7	
ation (Guide	
ase at		
ase at	Lacii.	
	1	
	anca!	
ır proj	Josai,	
al.		
their		
	1.1	
and -	adal-	
and m	odels	
	1	

PAST/PRESENT LAND USES
State the past known uses of the site: Pomeshi residence
State the past known uses of the site: Pomeshi residence State the present known uses of the site: Done Shic residence
STAGED DEVELOPMENT
You can apply for development consent for only part of your proposal now, and for the remaining part/s at a later time.
Are you applying for development consent in stages? Yes No
Information which describes the stages of your development;
 A copy of any development consents you already have which relate to your development.
you all eady flave which relate to your development.
PLANS OF THE LAND AND DEVELOPMENT
You need to provide a number of different plans that show what you intend to do. Step 4 of the Development Application Guids sets out which plans to provide and the details to include. Please submit 1 copy of the plans with the application. Please attach: A site plan of the land, drawn to scale; Plans or drawings of the proposal, drawn to scale and, where relevant; An A4 size plan of the proposed building and other structures on the site; A plan of any existing buildings (and uses), drawn to scale.
ENVIRONMENTAL EFFECTS OF YOUR DEVELOPMENT
To assess your proposal, we need to understand the impacts it will have. Depending upon the nature and scale of your proposal you need to provide one or more of the statements listed by
you need to provide one or more of the statements listed below to explain the environmental effects of your proposal.
Is your proposal likely to cause a major environmental impact (e.g. designated development)? Please attach an environmental impact (e.g. designated development)?
Yes Please attach an environmental impact statement. No Please attach a statement of environmental effects (SEE).
a statement of environmental effects (SEE).
Is your proposal likely to cause have significant effect on threatened species, populations, ecological communities or their habitats?
Yes Please attach a species impact statement.
SUPPOPTING INFORMATION
SUPPORTING INFORMATION
You can support your application with additional material such as photographs (including aerial photographs), slides and models to illustrate your proposal.
Please list what you have attached.
- Plans - Survey plan
- Environmental plan - waste water amendment
- I wend ment

NOTE: It will be necessary for you to place pegs showing the location of all building extremities and height of buildings within seven days of lodging your development application. These pegs will allows inspection by Board staff at an early stage of your development assessment.

Lord Howe Island Board

Development Application

Version December 2020

Page 2 of 4

APPLICATION FEE

For development that involves a building or other work, the fee for your application is based on the estimated cost of the development. If your development needs to be advertised to the public you may also need to include an advertising fee. Clauses 246 to 263 of the Environmental Planning and Assessment Regulation 2000 provide a schedule of fees.

NOTE: Fees will be calculated in accordance with Cordell's Building estimates and will form the basis for the fee. To save time and any delays in processing your application, please contact us if you need help to calculate the fee for your application.

APPLICANT/S OR APPLICANT'S AGENT DECLARATION Have you or any associated persons with a financial interest in this application in the last two years made any political donations or given any gifts to any local Board Member or Board employee? Yes Ano If you ticked yes please fill out a Political Donations and Gift Disclosure Statement. IMPORTANT NOTICE: It is an offence under the EP&A Act 1979 if you fail to disclose reportable donations and gifts. LEASEHOLDER AUTHORISATION — All leaseholder/s of the land must sign this application. As the leaseholder/s of the above property, I/we consent to this application. Signature: Signature: Name: APPLICANT AUTHORISATION — The applicant/s or the applicant's agent must sign the application. I apply for consent to carry out the development described in this application. I declare that all the information given is true and correct. I also understand that, if incomplete, the application may be delayed or rejected and more information may be requested within 21 days of lodgement. Signature: Signature: Signature: Name: Name: Name: Date: Date: Date: Signature: Signat	Estimated cost of the 20/03/202 4 — Fees	e development:\$ paid \$	450,000	\$ 4 00 ₁ 000 enter	red on the portal D	A fees based on \$ 40	0.000 — Rec:25950
Have you or any associated persons with a financial interest in this application in the last two years made any political donations or given any gifts to any local Board Member or Board employee? Yes No If you ticked yes please fill out a Political Donations and Gift Disclosure Statement. IMPORTANT NOTICE: It is an offence under the EP&A Act 1979 if you fail to disclose reportable donations and gifts. LEASEHOLDER AUTHORISATION — All leaseholder/s of the land must sign this application. As the leaseholder/s of the above property, I/we consent to this application. Signature: Signature: Name: Date: Name: Date: Signature is true and correct. I also understand that, if incomplete, the application may be delayed or rejected and more information may be requested within 21 days of lodgement. Signature: Name: Na	Total fees lodged:	Ŋate:	Red	ceipt No.:	2 59)50 20/03/202 4 - \$	5
or given any gifts to any local Board Member or Board employee?							
IMPORTANT NOTICE: It is an offence under the EP&A Act 1979 if you fail to disclose reportable donations and gifts. LEASEHOLDER AUTHORISATION — All leaseholder/s of the land must sign this application. As the leaseholder/s of the above property, I/we consent to this application. Signature: Signature: Name: Date: APPLICANT AUTHORISATION — The applicant/s or the applicant's agent must sign the application. I apply for consent to carry out the development described in this application. I declare that all the information given is true and correct. I also understand that, if incomplete, the application may be delayed or rejected and more information may be requested within 21 days of lodgement. Signature: Signature: Signature: Name: Name: Name:						nade any political do	nations
LEASEHOLDER AUTHORISATION – All leaseholder/s of the land must sign this application. As the leaseholder/s of the above property, I/we consent to this application. Signature: Signature: Name: Date: APPLICANT AUTHORISATION – The applicant/s or the applicant's agent must sign the application. I apply for consent to carry out the development described in this application. I declare that all the information given is true and correct. I also understand that, if incomplete, the application may be delayed or rejected and more information may be requested within 21 days of lodgement. Signature: Signature: Name: Name: Date: Date:	If you ticked yes plea	ase fill out a Political Do	nations and Gift Dis	closure Statement			
As the leaseholder/s of the above property, I/we consent to this application. Signature: Name: Joshua R. Quitas Name: Date: 16 / 1 / 2 4 Date: APPLICANT AUTHORISATION — The applicant/s or the applicant's agent must sign the application. I apply for consent to carry out the development described in this application. I declare that all the information given is true and correct. I also understand that, if incomplete, the application may be delayed or rejected and more information may be requested within 21 days of lodgement. Signature: Signature: Name: Name: Date: Date:	IMPORTANT NOTICE	: It is an offence under	the EP&A Act 1979 i	f you fail to disclo	se reportable dona	tions and gifts.	
Signature: Name: Joshua R. Cuttus Name: Date: 16. 1/2 4 Date: APPLICANT AUTHORISATION – The applicant/s or the applicant's agent must sign the application. I apply for consent to carry out the development described in this application. I declare that all the information given is true and correct. I also understand that, if incomplete, the application may be delayed or rejected and more information may be requested within 21 days of lodgement. Signature: Signature: Name: Name: Date:	LEASEHOLDER AU	THORISATION - All le	aseholder/s of the la	and must sign this	application.		
Name:	As the leaseholder/s	of the above property,	I/we consent to this	s application.			
Date:	Signature;			Signature:			
APPLICANT AUTHORISATION — The applicant/s or the applicant's agent must sign the application. I apply for consent to carry out the development described in this application. I declare that all the information given is true and correct. I also understand that, if incomplete, the application may be delayed or rejected and more information may be requested within 21 days of lodgement. Signature: Name: Name: Date:	Name: Jossy	MAR. OU	ĒNS.	Name: ,	147 117		
I apply for consent to carry out the development described in this application. I declare that all the information given is true and correct. I also understand that, if incomplete, the application may be delayed or rejected and more information may be requested within 21 days of lodgement. Signature: Name: Name: Date:	Date:	124	3° 61	Date:			r= -
I apply for consent to carry out the development described in this application. I declare that all the information given is true and correct. I also understand that, if incomplete, the application may be delayed or rejected and more information may be requested within 21 days of lodgement. Signature: Name: Name: Date:	APPLICANT AUTHO	ORISATION - The appl	icant/s or the applic	ant's agent must s	ign the application		
Name:	I apply for consent to and correct. I also un	o carry out the develop nderstand that, if incom	ment described in th	nis application. I de	eclare that all the in	nformation given is tr	
Name:	Signature:	9		Signature:			
Date:			Ţ ¹ ,	0.4		the officer of	
	Name:			Name:			
State the capacity in which you are signing if you are not the applicant:	Date:			Date:			<u>.</u>
	State the capacity in	which you are signing i	f you are not the ap	plicant:			
	3/		18,	A Just			
			<i>y</i> ,			1	

PRIVACY POLICY

The information you provide in this application will enable us, and any relevant state agency, to assess your application under the Environmental Planning and Assessment Act 1979 and other applicable state legislation. If the information is not provided, your application may not be accepted.

If your application is for designated development or advertised development, it will be available for public inspection and copying during a submission period. Your application, and any attached plans will be published on the Lord Howe Island Board website. Written notification of the application will also be provided to the neighbourhood. You have the right to access and have corrected information provided in your application. Please ensure that the information is accurate and advise us of any changes.

Lord Howe Island Board

Development Application

Documentation provided with an application may also be accessed in accordance with the requirements of the Government Information Access (GIPA) Act 2009. LODGEMENT Before submitting your application, please ensure you have attached all the information the consent authority needs to assess your proposal. You can use the following checklist. Please place a cross in the box \square next to any items you have attached: Plans A site plan of the land - all applications Plans or drawings of the proposal showing all dimensions — all applications An A4 size plan of the proposed building and other structures on the site - all applications A plan which is drawn to scale of all existing buildings. **Environmental effects** An environmental impact statement for a designated development proposal and an electronic version of the executive summary A statement of environmental effects — required for all applications that are not designated development An environmental report — if required under clause 42 of the LHI LEP 2010. Contact the Board to see if you need to prepare an environmental report. A species impact statement A Basix Certificate - The Building Sustainability Index (BASIX) applies to all residential dwelling types and is part of the development application process in NSW. A BASIX certificate MUST be obtained for "BASIX affected development". For further information please refer to www.basix.nsw.gov.au Electrical supply form must be completed (for new / alteration / addition to existing supply). Staged development Information which describes the stages of the development A copy of any consents already granted for part of the development Supporting information Other material to support your application, such as photos, slides and models. Please ensure any items listed as an Advisory Note as part of the Owner Consent approval have been addressed. Your application fee — required for all applications. Where to lodge your application You can lodge your completed application form, together with attachments and fees at the Lord Howe Island Board's office. CONTACT DETAILS FOR YOUR INFORMATION Lord Howe Island Board Department of Infrastructure, Planning and Natural **Bowker Avenue** Resources - General Enquiries (PO Box 5) Phone: LORD HOWE ISLAND NSW 2898 Email: Website: www.dipnr.nsw.gov.au Department of Infrastructure, Planning and Natural www.lhib.nsw.gov.au Resources - North Coast Office Lord Howe Island Marine Park Authority 49 Victoria Street Phone: (PO Box 6) Fax: **GRAFTON NSW 2460** Email: Phone:

Email:

Website:

www.dipnr.nsw.gov.au

BASIX Certificate: www.basix.nsw.gov.au

Lord Howe Island Board

www.mpa.nsw.gov.au

Website:

Development Application

Version December 2020 Page 4 of 4

<u>Development Application Statement – Amendment/Extension to</u> <u>existing dwelling; demolish existing garage; relocate wastewater</u> <u>irrigation field for existing wastewater system</u>

Land Information

Lot: 11

DP:1202580

Perpetual Lease number: 2015.01

Development type: Amendment/Extension to existing dwelling to increase living space and store building material; demolish existing garage; relocate wastewater irrigation field for existing wastewater system

Leaseholder: Joshua Roylance Owens

Overview Statement

We wish to undertake extensions to our existing dwelling at Island. The proposed extension aims to create more space for our family as it grows, including additional bedrooms, bathrooms, and larger shared living spaces (kitchen, dining etc). To make space we will also be demolishing an existing lean-to garage.

We also wish to change the location of the existing irrigation field as the lot has been subdivided since the original install of the wastewater system. It is currently on the neighbouring lot (DP1261010-1), and we would like to move it to our lot (1202580-11). See the attached wastewater management plan for further information.

LEP Regulations

Zoning

The lot is within the LEP Settlement Zone, which aims to provide residential development. As this building is our primary residence, this is in line with the LEP zoning rules (figure 1).

Foreshore Building & Heritage

The development is not within the Foreshore Building Line and does not contain any heritage buildings.

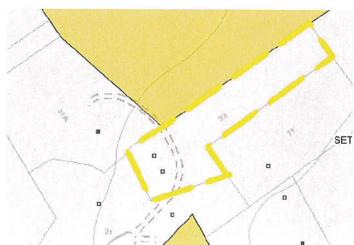


Figure 1. Map of LEP zones in reference to 33 Anderson Road (yellow border), with the Settlement Zone shown in pink. Source: NSW Planning

Significant Native Vegetation (SNV)

The proposed development is on land that is currently open lawn, so no vegetation removal will be required. It does not overlap with any SNV, so no SNV will be damaged or removed by this development either (figure 2). Additionally, current SNV covers more than 50% of the block footprint, which is well over the 35% block area required for endemic species. The remainder of the undeveloped block footprint is landscaped garden (~30% of block).

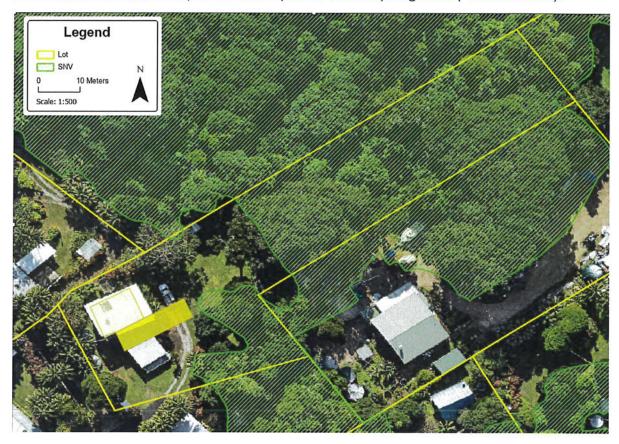


Figure 2. SNV in relation to proposed development.

Appearance

The house appearance will be in sympathy with the surrounding environment and will be painted in the same colours as the current, already approved dwelling. Proposed colours are within the LHI colour scheme - Surf Mist colourbond and White Villaboard cladding. The house will not obscure any existing views and will be screened from adjacent properties.

Building height will be less than 6.3m (height of current approved dwelling). The extension will be the same absolute height but extends up a slight slope on the block. It will be cut into the landscape to ensure the buildings are level which would result in a lower building height compared to the surrounding ground level for the new extension.

Building Footprint & Existing Structures

The footprint of the new extension is over an existing shed/garage. The existing structure will be fully demolished to allow for the new build (figure 3).

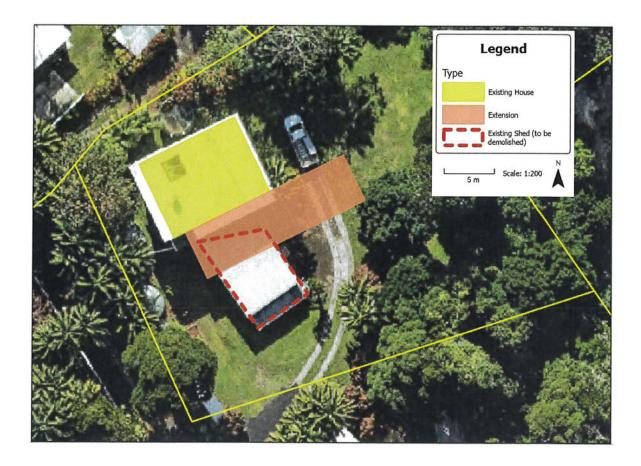


Figure 3. Location of proposed building footprint in relation to existing built structures on the lot.

Information about vehicular ingress/egress can be found in the attached Access Statement. All other information relating to this DA can be found within the LHIB DA application documents.

LORD HOWE ISLAND BOARD Statement of Environmental Effects

A Statement of Environmental Effects must be completed and submitted with your development application, this is a requirement under the Environmental Planning & Assessment Act 1979. The Statement of Environmental Effects report explains the likely impacts of the development proposal taking into consideration relevant planning and environmental matters. If you require any clarification about what information needs to be included, please contact the Board's office on (02) 6563 2066.

Failure to submit a completed Statement of Environmental Effects report will result in the development application being rejected or incurring unnecessary delays before the application can be determined.

	Burn VIV Vivi al a
Name: Joshua	4 ROYLANCE OWERS
Signed:	Date: 15/1/24
o great in	Date:
PROPOSED DEVELOPME	ENT
Portion/Lot No.: 11	Deposited Plan No.: DP 1202580
ease No.: 2015	
Address:	
Please tick the type/s of de	evelopment you are applying for:
Dwelling House Additions to Dwelling I Home Business Commercial	House Shed or Garage Dual Occupancy Additions to Dual Occupancy Subdivision including Boundary Realignments
✓ Other – please describ	be: Relocation of wastewater irrigation field for existing wastewater syst
DEVELOPMENT DESIGN	IATTRIBUTES
	NATTRIBUTES
XISTING BUILDINGS What buildings and/or stru	가게 있는 것 같습니다.
EXISTING BUILDINGS What buildings and/or structors floor area where app - EXISTA	ructures already exist on the subject site? Existing structures located on the subject site (including their plicable) as well as adjoining properties need to be shown on a site plan. Please show floor space. Any dwelling with a sposs floor area of
EXISTING BUILDINGS What buildings and/or structures floor area where app	ructures already exist on the subject site? Existing structures located on the subject site (including their plicable) as well as adjoining properties need to be shown on a site plan. Please show floor space. 19 dwelling with a 5055 floor area of m² (both Stories)
EXISTING BUILDINGS What buildings and/or structors floor area where approximately the structors of the struc	d exsension would increase gross
EXISTING BUILDINGS What buildings and/or structors floor area where approved the structors of the structors	destension would increase gross Lead to 289m ² weatho 289m ² Line distribution of the subject site? Existing structures located on the subject site (including their plicable) as well as adjoining properties need to be shown on a site plan. Please show floor space. Lead of the stories of the subject site (including their plicable) as well as adjoining properties need to be shown on a site plan. Please show floor space. Lead to the subject site? Existing structures located on the subject site (including their plicable) as well as adjoining properties need to be shown on a site plan. Please show floor space. Lead to the stories of the stories of the subject site (including their plicable) as well as adjoining properties need to be shown on a site plan. Please show floor space. Lead to the stories of
EXISTING BUILDINGS What buildings and/or structures floor area where app - Existin 110.93 Propose Ploor a. - There is	uctures already exist on the subject site? Existing structures located on the subject site (Including their plicable) as well as adjoining properties need to be shown on a site plan. Please show floor space. Any dwelling with a gross floor area of m² (both stories) d extension would increase gross rea to 288m² an existing bldshed on site which will
EXISTING BUILDINGS What buildings and/or structors floor area where app - Existin 110.93 Propose Ploor a. - There is	destension would increase gross Lead to 289m ² weatho 289m ² Line distribution of the subject site? Existing structures located on the subject site (including their plicable) as well as adjoining properties need to be shown on a site plan. Please show floor space. Lead of the stories of the subject site (including their plicable) as well as adjoining properties need to be shown on a site plan. Please show floor space. Lead to the subject site? Existing structures located on the subject site (including their plicable) as well as adjoining properties need to be shown on a site plan. Please show floor space. Lead to the stories of the stories of the subject site (including their plicable) as well as adjoining properties need to be shown on a site plan. Please show floor space. Lead to the stories of

Page 1 of 8

DEVELOPMENT CONSENTS

If known, please list previous development and building approvals for the last 10 years which are considered relevant to this application. If necessary please consult Board staff.

DA Number

Development Description

Date of Consent

14/7/09

OWNERS CONSENT

Please provide the reference number for the Owners Consent application. Please confirm that all conditions of owners consent have been met for this development application.

DEVELOPMENT REQUIREMENTS

DWELLINGS/RESIDENTIAL

Does your development comply with the maximum gross floor area and the minimum dwelling area (under Clause 20 & 23 LHI Local Environmental Plan 2010)? If yes, this must be demonstrated below.

Ves. Bloch Size is 3000m².

Proposed building is 288m². Max allowance

300m²

Please specify if your development complies with the enlargements or extensions of a dwelling (under clause 27 LHI Local Environmental Plan 2010)? If yes, this must be demonstrated below.

Yes elocate sting waster atersystem in complies with

Yes elocate sting waster atersystem sin couplies with

COMMERCIAL

Please specify if your development complies with the requirements in Clause 22 for tourist accommodation, staff accommodation and commercial premises? If yes, this must be demonstrated below.

N/A

ALL BUILDINGS - MAXIMUM BUILDING HEIGHT

Please specify if your development complies with the maximum building height (under clause 29 LHI LEP 2010)? If yes, this must be demonstrated below.

Building height is less than 6.3m

Ly defect the property of the property of the last

Lord Howe Island Board

Statement of Environmental Effects

Version Nov 2022 Page 2 of 8

14	100	7 (2
/		
	V. 24	V 1/2 2 4
ING	1	
s your development meet the objective	es of the zone in which the site is in? Please provide how	the development meets
e objectives (clause 13-19 LHI LEP 2010	0).	
The zone is s	settlement, which aims i	prouble
	1 7 7 7	nonde Phis
nin As il in wei	dertal development in symponment, and is in line with	why to the
MW as a contra	The same of good is in lives with	settlement soning
ERGY EFFICIENCY	Shoppy in the same	
	m DACIV requirements? In opinionic which is a brown	
mitted with your application please ref	for to www.basix.nsw.gov.au/information/index.jsp. Eac	if development apparent
esidential dwelling and each developme	ent application for alterations and additions must have a	ada al a su
Yes		
Company of the Addition	7	E/V
Α		
	/	1317771
UNDARY SETBACKS	the front houndary?	
w far is your development setback from	the front boundary?	
UNDARY SETBACKS w far is your development setback from	the front boundary?	
w far is your development setback from	the front boundary?	
w far is your development setback from	the front boundary?	
w far is your development setback from		
w far is your development setback from		
w far is your development setback from		
w far is your development setback from		
w far is your development setback from	the side and rear boundaries?	
w far is your development setback from		sons why the development
w far is your development setback from When the setback from When	the side and rear boundaries?	sons why the development
w far is your development setback from w far is your development setback from (the side and rear boundaries?	sons why the development
w far is your development setback from w far is your development setback from (the side and rear boundaries? ard's minimum setback requirements? If no, provide rea	sons why the development
w far is your development setback from w far is your development setback from (the side and rear boundaries? ard's minimum setback requirements? If no, provide rea	sons why the development
w far is your development setback from w far is your development setback from (the side and rear boundaries? ard's minimum setback requirements? If no, provide rea	sons why the developmen

noistal	duelli		410.	11	•	~ 1 +
neight.	owny	prepe-	-カモノ、	17 15 1	popo	, Jea R
Screen.	further	on o	oup let	•7		1 7 1
AND ADJACENT TO ZO	NE 7 OR 8					
lease specify if your de	velopment complies	s with the require	ments for land ad	jacent to Zone 7 c	r 8 (under o	lause 34 LHI LEP
010)? If yes, this must I	be demonstrated be	elow.	Ve ve	1		
NA			1 . 1	Marky C.		
0	(11) IV	(-21)	a enyotie	V V V V V V	Section 1.	V 14 /
	1.18.16	n tyrevy	271/1-12	i (2 112.19)		7.6
			<u> </u>)
ONSTRAINTS		0.17				1
· · · · · · · · · · · · · · · · · · ·			p-	8		
ORESHORE DEVELOPM			s vy		A .	4 1 1
your land within the fo	preshore developme	ent area? If yes, p	lease how the dev	elopment compli	es with fore:	shore developme
equirements (Clause 35	LHI LEP 2010).					E 30
NIA						1

						5.
				Y		
AIRCRAFT NOISE						20.3
your land subject to the vith the application.	ne Australian Noise I	Exposure Forecas	t? If yes, the deve	lopment may nee	d to include	an Acoustic Repo
1.						
N/A			***************************************			
						1 + 6 1
			***************************************		, e	7 V V V V V
LOODING						
your land flood prone?						
	ntly drained from yo				ighbours.	
• the proposed (development will i	not be adversely	y affected by flo	oding.		V -2/-
			•••••••••••		***************************************	
16/0						
NA					***************************************	

LANDSCAPING

he development listed as a heritage item, located in a heritage conservation area or located adjacent to any known heritage mor archaeological site? If yes, a Statement of Heritage Impact and referral to NSW Heritage Branch may be required.	HERITAGE	
GNIFICANT VEGETATION (iii) the development require the removal of any vegetation in areas mapped as 'significant vegetation' in LHI LEP 2010 Sheet is swell as the proposed 'significant vegetation' map on exhibition? If yes, the proposed development may be prohibited. ***CRETENTION OF TREES AND LANDSCAPING** Will the development require the removal of any native trees and/or shrubs? If yes, please specify how many trees/shrubs not to be removed and indicate their location on the site/landscape plan. ***CRECOVERY PLANS AND HABITAT AREAS** Is the development consistent with approved Recovery Plans for the island? Does the development have any impacts on threatened species? If the answer to this question is yes then an Environmental Report, a seven part test or a Species Impact Statement may be required (Clause 42 of LHI Local Environment Plan 2010). It is important to remember that it is illegal to clauding, underscrub or remove any vegetation within areas of identified habitat. ***No Only 10 Statement Teach Statement Plan 2010	the development listed as a heritage item, located in a heritage conservation area	or located adjacent to any known heritage
FRECOVERY PLANS AND HABITAT AREAS Is the development consistent with approved Recovery Plans for the island? Does the development have any impacts on threatened species? If the answer to this question is yes then an Environmental Report, a seven part test or a Species Impact Statement may be required (Clause 42 of LHI Local Environment Plan 2010). It is important to remember that it is illegal to clamodify, underscrub or remove any vegetation within areas of identified habitat.	em or archaeological site? If yes, a Statement of Heritage Impact and referral to NS	SW Heritage Branch may be required.
FRECOVERY PLANS AND HABITAT AREAS Is the development consistent with approved Recovery Plans for the island? Does the development have any impacts on threatened species? If the answer to this question is yes then an Environmental Report, a seven part test or a Species Impact Statement may be required (Clause 42 of LHI Local Environment Plan 2010). It is important to remember that it is illegal to clamodify, underscrub or remove any vegetation within areas of identified habitat.	N/A	
FRECOVERY PLANS AND HABITAT AREAS Is the development consistent with approved Recovery Plans for the island? Does the development have any impacts on threatened species? If the answer to this question is yes then an Environmental Report, a seven part test or a Species Impact Statement may be required (Clause 42 of LHI Local Environment Plan 2010). It is important to remember that it is illegal to clamodify, underscrub or remove any vegetation within areas of identified habitat.	· · · · · · · · · · · · · · · · · · ·	
FRECOVERY PLANS AND HABITAT AREAS Is the development consistent with approved Recovery Plans for the island? Does the development have any impacts on threatened species? If the answer to this question is yes then an Environmental Report, a seven part test or a Species Impact Statement may be required (Clause 42 of LHI Local Environment Plan 2010). It is important to remember that it is illegal to clamodify, underscrub or remove any vegetation within areas of identified habitat.		
FRECOVERY PLANS AND HABITAT AREAS Is the development consistent with approved Recovery Plans for the island? Does the development have any impacts on threatened species? If the answer to this question is yes then an Environmental Report, a seven part test or a Species Impact Statement may be required (Clause 42 of LHI Local Environment Plan 2010). It is important to remember that it is illegal to clamodify, underscrub or remove any vegetation within areas of identified habitat.		
FRECOVERY PLANS AND HABITAT AREAS Is the development consistent with approved Recovery Plans for the island? Does the development have any impacts on threatened species? If the answer to this question is yes then an Environmental Report, a seven part test or a Species Impact Statement may be required (Clause 42 of LHI Local Environment Plan 2010). It is important to remember that it is illegal to clamodify, underscrub or remove any vegetation within areas of identified habitat.		
FRECOVERY PLANS AND HABITAT AREAS Is the development consistent with approved Recovery Plans for the island? Does the development have any impacts on threatened species? If the answer to this question is yes then an Environmental Report, a seven part test or a Species Impact Statement may be required (Clause 42 of LHI Local Environment Plan 2010). It is important to remember that it is illegal to clamodify, underscrub or remove any vegetation within areas of identified habitat.		
FRECOVERY PLANS AND HABITAT AREAS Is the development consistent with approved Recovery Plans for the island? Does the development have any impacts on threatened species? If the answer to this question is yes then an Environmental Report, a seven part test or a Species Impact Statement may be required (Clause 42 of LHI Local Environment Plan 2010). It is important to remember that it is illegal to clamodify, underscrub or remove any vegetation within areas of identified habitat.		
FRECOVERY PLANS AND HABITAT AREAS Is the development consistent with approved Recovery Plans for the island? Does the development have any impacts on threatened species? If the answer to this question is yes then an Environmental Report, a seven part test or a Species Impact Statement may be required (Clause 42 of LHI Local Environment Plan 2010). It is important to remember that it is illegal to clamodify, underscrub or remove any vegetation within areas of identified habitat.	/15 / 15 / 17 / 17 / 17 / 17 / 17 / 17 /	
RETENTION OF TREES AND LANDSCAPING Will the development require the removal of any native trees and/or shrubs? If yes, please specify how many trees/shrubs not be removed and indicate their location on the site/landscape plan. **RECOVERY PLANS AND HABITAT AREAS** Is the development consistent with approved Recovery Plans for the island? Does the development have any impacts on threatened species? If the answer to this question is yes then an Environmental Report, a seven part test or a Species Impact Statement may be required (Clause 42 of LHI Local Environment Plan 2010). It is important to remember that it is illegal to clamodify, underscrub or remove any vegetation within areas of identified habitat. **No** **Can the development be sited to retain existing vegetation? If no, explain why this is not possible.**		La North Control
RETENTION OF TREES AND LANDSCAPING Will the development require the removal of any native trees and/or shrubs? If yes, please specify how many trees/shrubs not to be removed and indicate their location on the site/landscape plan. **RECOVERY PLANS AND HABITAT AREAS** Is the development consistent with approved Recovery Plans for the island? Does the development have any impacts on threatened species? If the answer to this question is yes then an Environmental Report, a seven part test or a Species Impact Statement may be required (Clause 42 of LHI Local Environment Plan 2010). It is important to remember that it is illegal to claim of the control of the con		
Will the development require the removal of any native trees and/or shrubs? If yes, please specify how many trees/shrubs not be removed and indicate their location on the site/landscape plan. **RECOVERY PLANS AND HABITAT AREAS** Is the development consistent with approved Recovery Plans for the island? Does the development have any impacts on threatened species? If the answer to this question is yes then an Environmental Report, a seven part test or a Species Impact Statement may be required (Clause 42 of LHI Local Environment Plan 2010). It is important to remember that it is illegal to cle modify, underscrub or remove any vegetation within areas of identified habitat. **No** **Can the development be sited to retain existing vegetation? If no, explain why this is not possible.**	is well as the proposed 'significant vegetation' map on exhibition? If yes, the propo	sed development may be pronibited.
Will the development require the removal of any native trees and/or shrubs? If yes, please specify how many trees/shrubs not be removed and indicate their location on the site/landscape plan. **RECOVERY PLANS AND HABITAT AREAS** Is the development consistent with approved Recovery Plans for the island? Does the development have any impacts on threatened species? If the answer to this question is yes then an Environmental Report, a seven part test or a Species Impact Statement may be required (Clause 42 of LHI Local Environment Plan 2010). It is important to remember that it is illegal to cle modify, underscrub or remove any vegetation within areas of identified habitat. **No** **Can the development be sited to retain existing vegetation? If no, explain why this is not possible.**	N/A	
Will the development require the removal of any native trees and/or shrubs? If yes, please specify how many trees/shrubs not be removed and indicate their location on the site/landscape plan. **RECOVERY PLANS AND HABITAT AREAS** Is the development consistent with approved Recovery Plans for the island? Does the development have any impacts on threatened species? If the answer to this question is yes then an Environmental Report, a seven part test or a Species Impact Statement may be required (Clause 42 of LHI Local Environment Plan 2010). It is important to remember that it is illegal to cle modify, underscrub or remove any vegetation within areas of identified habitat. **No** **Can the development be sited to retain existing vegetation? If no, explain why this is not possible.**		7
Will the development require the removal of any native trees and/or shrubs? If yes, please specify how many trees/shrubs not be removed and indicate their location on the site/landscape plan. **RECOVERY PLANS AND HABITAT AREAS** Is the development consistent with approved Recovery Plans for the island? Does the development have any impacts on threatened species? If the answer to this question is yes then an Environmental Report, a seven part test or a Species Impact Statement may be required (Clause 42 of LHI Local Environment Plan 2010). It is important to remember that it is illegal to cle modify, underscrub or remove any vegetation within areas of identified habitat. **No** **Can the development be sited to retain existing vegetation? If no, explain why this is not possible.**		
Will the development require the removal of any native trees and/or shrubs? If yes, please specify how many trees/shrubs not be removed and indicate their location on the site/landscape plan. **RECOVERY PLANS AND HABITAT AREAS** Is the development consistent with approved Recovery Plans for the island? Does the development have any impacts on threatened species? If the answer to this question is yes then an Environmental Report, a seven part test or a Species Impact Statement may be required (Clause 42 of LHI Local Environment Plan 2010). It is important to remember that it is illegal to cle modify, underscrub or remove any vegetation within areas of identified habitat. **No** **Can the development be sited to retain existing vegetation? If no, explain why this is not possible.**		
Will the development require the removal of any native trees and/or shrubs? If yes, please specify how many trees/shrubs not be removed and indicate their location on the site/landscape plan. **RECOVERY PLANS AND HABITAT AREAS** Is the development consistent with approved Recovery Plans for the island? Does the development have any impacts on threatened species? If the answer to this question is yes then an Environmental Report, a seven part test or a Species Impact Statement may be required (Clause 42 of LHI Local Environment Plan 2010). It is important to remember that it is illegal to cle modify, underscrub or remove any vegetation within areas of identified habitat. **No** **Can the development be sited to retain existing vegetation? If no, explain why this is not possible.**		
Is the development consistent with approved Recovery Plans for the island? Does the development have any impacts on threatened species? If the answer to this question is yes then an Environmental Report, a seven part test or a Species Impact Statement may be required (Clause 42 of LHI Local Environment Plan 2010). It is important to remember that it is illegal to clamodify, underscrub or remove any vegetation within areas of identified habitat. **Con the development be sited to retain existing vegetation? If no, explain why this is not possible.**		
Is the development consistent with approved Recovery Plans for the island? Does the development have any impacts on threatened species? If the answer to this question is yes then an Environmental Report, a seven part test or a Species Impact Statement may be required (Clause 42 of LHI Local Environment Plan 2010). It is important to remember that it is illegal to cle modify, underscrub or remove any vegetation within areas of identified habitat. **Con the development be sited to retain existing vegetation? If no, explain why this is not possible.**		
Is the development consistent with approved Recovery Plans for the island? Does the development have any impacts on threatened species? If the answer to this question is yes then an Environmental Report, a seven part test or a Species Impact Statement may be required (Clause 42 of LHI Local Environment Plan 2010). It is important to remember that it is illegal to cle modify, underscrub or remove any vegetation within areas of identified habitat. **Con the development be sited to retain existing vegetation? If no, explain why this is not possible.**		2 49
Is the development consistent with approved Recovery Plans for the island? Does the development have any impacts on threatened species? If the answer to this question is yes then an Environmental Report, a seven part test or a Species Impact Statement may be required (Clause 42 of LHI Local Environment Plan 2010). It is important to remember that it is illegal to cle modify, underscrub or remove any vegetation within areas of identified habitat. **Con the development be sited to retain existing vegetation? If no, explain why this is not possible.**		
Is the development consistent with approved Recovery Plans for the island? Does the development have any impacts on threatened species? If the answer to this question is yes then an Environmental Report, a seven part test or a Species Impact Statement may be required (Clause 42 of LHI Local Environment Plan 2010). It is important to remember that it is illegal to cle modify, underscrub or remove any vegetation within areas of identified habitat. **Con the development be sited to retain existing vegetation? If no, explain why this is not possible.**	DECOVEDY DI ANS AND HARITAT APEAS	COLUMN TO THE RESERVE
threatened species? If the answer to this question is yes then an Environmental Report, a seven part test or a Species Impact Statement may be required (Clause 42 of LHI Local Environment Plan 2010). It is important to remember that it is illegal to cle modify, underscrub or remove any vegetation within areas of identified habitat. Can the development be sited to retain existing vegetation? If no, explain why this is not possible.		he development have any impacts on
Statement may be required (Clause 42 of LHI Local Environment Plan 2010). It is important to remember that it is illegal to cle modify, underscrub or remove any vegetation within areas of identified habitat. **Comparison of the development of the comparison of the development of the comparison of the comparison of the development of the comparison of	threatened species? If the answer to this question is yes then an Environmental Rep	port, a seven part test or a Species Impact
Can the development be sited to retain existing vegetation? If no, explain why this is not possible.	Statement may be required (Clause 42 of LHI Local Environment Plan 2010). It is imp	portant to remember that it is illegal to cle
Can the development be sited to retain existing vegetation? If no, explain why this is not possible.	modify, underscrub or remove any vegetation within areas of identified habitat.	Alaysi II.
Can the development be sited to retain existing vegetation? If no, explain why this is not possible.	Mo	
	100	
		P. Hart M.
Yes	Can the development be sited to retain existing vegetation? If no, explain why this is	s not possible.
	Voc	
	142	
	그 내고 주민이 그리는 이 그런 하지만 하는데 그 모든 그래?	

100	EVICA					,		
/	Exten.)/ <i>o</i> /	5 ON	- 0/	ren	lawr	<u> </u>	
				••••••		***************************************		
ISUAL APPEARAN								
operties and cha	ternal appearance tracter of the area	•S						
Noo	versha	dowing	2 of c	odja	cent	pro	ort:	ررم
enviro	nnenta	Un fr	iendly	1 0	100-	+ mi	rteri	911,
Non	refle c	tive	teer	, e	Heno	cl cl	a ddi	ng
simila	- to a	djace	nt b	uile	ding	J	· · · · · · · · · · · · · · · · · · ·	
SUAL AND ACOU	STIC PRIVACY							
scribe how the c	development has t	een designed	to reduce any	possible i	mpact on the	e visual or ac	oustic priva	cy of adjoinin
	er the use of scree							
Smal	1 wine	lews	fa cin	y a	djac	n+p	rope	Are,
Thich	boad	of to	PPI	do-f	~ .	Aug S.	N .	14 1/
IVLIC	2001	0 1 11		neir	441	noil	0	
1011051	2077			ce ir	493	noll	e	
/ VIICS	2077			ve ir	493	No(J	e	
DLAR ACCESS	2077	<u> </u>		oe ir	493	No(J	e	
DLAR ACCESS as the developme	ent been designed	so that the m	ain indoor and	l outdoor l	iving spaces			ske advantage
DLAR ACCESS as the development lar access? If yes	ent been designed , please specify th	so that the m	ain indoor and	i outdoor l	iving spaces d east.	face north a	nd east to ta	
DLAR ACCESS as the developmental ar access? If yes	ent been designed	so that the m	ain indoor and	i outdoor l	iving spaces d east.	face north a	nd east to ta	
DIAR ACCESS Is the development of the second	ent been designed , please specify th	so that the me e parts of the	ain indoor and	i outdoor l	iving spaces d east.	face north a	nd east to ta	
DIAR ACCESS as the development of the development o	ent been designed , please specify th	so that the me e parts of the	ain indoor and	i outdoor l	iving spaces d east.	face north a	nd east to ta	
DIAR ACCESS Is the development of the second	ent been designed , please specify th	so that the me e parts of the	ain indoor and	i outdoor l	iving spaces d east.	face north a	nd east to ta	
DIAR ACCESS as the development of the development o	ent been designed , please specify th	so that the me e parts of the	ain indoor and	i outdoor l	iving spaces d east.	face north a	nd east to ta	
DLAR ACCESS as the developmed lar access? If yes Yes Will	ent been designed, please specify the	so that the me parts of the description	ain indoor and dwelling facin	i outdoor l	iving spaces d east.	face north a	nd east to ta	
PLAR ACCESS Is the development of the second	ent been designed , please specify th	so that the me parts of the description	ain indoor and dwelling facin	i outdoor l	iving spaces d east.	face north a	nd east to ta	
PLAR ACCESS is the developmed lar access? If yes Yes Will	ent been designed, please specify the	so that the me parts of the description	ain indoor and dwelling facin	i outdoor l	iving spaces d east.	face north a	nd east to ta	
DLAR ACCESS as the development of the second	ent been designed, please specify the	so that the me parts of the description	ain indoor and dwelling facin	i outdoor l	iving spaces d east.	face north a	nd east to ta	
DLAR ACCESS as the development of the second	ent been designed, please specify the	so that the me parts of the description	ain indoor and dwelling facin	i outdoor l	iving spaces d east.	face north a	nd east to ta	
DLAR ACCESS as the development of the second	ent been designed, please specify the	so that the me parts of the description	ain indoor and dwelling facin	i outdoor l	iving spaces d east.	face north a	nd east to ta	

he developmer									
No		A							
The second		***************************************	***************************************	•••••••	••••••				

	•••••	••••••							
ssible to site th	ne develop	ment to minin	nise the ob	struction of	views? If no, e	plain why	this is not	possib	le.
1/1	2.1								
							./.		
	Marian secon								
		•••••••••						ic.	
NG AND TRAF	FIC								
	100-100						volonmoni	2	
nany on-site pa									
ame awn	as	evila	tina	res	'den	co	Lo	ra	0
			y						
airea	are.	a for-		11					
2000	<i>0</i> (7 C)	00	()0	- VOIN	J			•••••	
			33.5	_					
the developme ease justify wh	y the deve				t impacting on	existing a	ccess and p	oarking	arrange
	y the deve				t impacting on	existing a	ccess and p	oarking	arrange
ease justify wh	y the deve				t impacting on	existing a	cess and p	oarking	arrange
ease justify wh	y the deve				t impacting on	existing ac	cess and p	parking	arrange
ease justify wh	y the deve				t impacting on	existing ac	ccess and p	oarking	arrango
ease justify wh	y the deve	lopment shoul			t impacting on	existing ac	ccess and p	parking	arrango
ease justify wh	y the deve	elopment shoul	ld be suppo	orted.			1		
ease justify where S	RETAINING o excavate	G WALLS	es, specify t	the maximur			1		
ease justify where S	RETAINING o excavate	G WALLS	es, specify t	the maximur			1		
HWORKS AND the site need to	RETAINING o excavate be shown	G WALLS	es, specify t	the maximur			1		
HWORKS AND the site need to	RETAINING o excavate be shown	G WALLS	es, specify t	the maximur			1		
HWORKS AND the site need to	RETAINING o excavate be shown	G WALLS	es, specify t	the maximur			1		
HWORKS AND the site need to	RETAINING o excavate be shown	G WALLS	es, specify t	the maximur			1		
HWORKS AND the site need to	RETAINING o excavate be shown	G WALLS	es, specify t	the maximur			1		
HWORKS AND the site need to	RETAINING o excavate be shown	G WALLS	es, specify t	the maximur			1		
HWORKS AND the site need to	RETAINING o excavate be shown	G WALLS	es, specify t	the maximur			1		
HWORKS AND the site need to	RETAINING o excavate be shown	G WALLS d or filled? If you	es, specify to	the maximur	n retaining wa	II heights a	and type of	fconst	ruction.
HWORKS AND the site need to	RETAINING o excavate be shown	G WALLS d or filled? If you	es, specify to	the maximur	n retaining wa	II heights a	and type of	fconst	ruction.
HWORKS AND the site need to details need to	RETAINING o excavate be shown	G WALLS d or filled? If you on the develop	es, specify to	the maximur	n retaining wa	II heights a	and type of	fconst	ruction.
HWORKS AND the site need to details need to	RETAINING o excavate be shown	G WALLS d or filled? If you on the develop	es, specify to	the maximur	n retaining wa	II heights a	and type of	fconst	ruction.
HWORKS AND the site need to details need to	RETAINING o excavate be shown	G WALLS d or filled? If you on the develop Howe Island Bo	es, specify toment plans	the maximur	n retaining wa	II heights a	and type of	fconst	ruction.
HWORKS AND the site need to details need to	RETAINING o excavate be shown	G WALLS d or filled? If you on the develop Howe Island Bo	es, specify toment plans	the maximurs.	n retaining wa	II heights a	and type of	fconst	ruction.
HWORKS AND the site need to details need to	RETAINING o excavate be shown	G WALLS d or filled? If you on the develop Howe Island Bo	es, specify toment plans	the maximurs.	n retaining wa	II heights a	and type of	fconst	ruction.
HWORKS AND the site need to details need to	RETAINING o excavate be shown	G WALLS d or filled? If you on the develop Howe Island Bo	es, specify toment plans	the maximurs.	n retaining wa	II heights a	and type of	fconst	ruction.

will excess stormwater runoff be d Stormwater		o vater t	-anks, over-floor
away from a			
OSION AND SEDIMENT CONTROL at erosion and sediment control me			onsider siltation fencing, diversion
Link Miller Har	and the second second		
NA	-	/_a/	17
ere will the erosion and sediment c liment control measures on the site		ided on-site? Please ident	ify the location of the erosion and
NIÁ	il e op the	A Liberty	A HARAGEROUS
		le co	For the order or the part
			······································
HER CONSIDERATIONS			1
there any other particular measure	es proposed to mitigate a	nd/or offset any significan	at impact caused by the development
The develope			
n SNV			
		and an	dise many pové na
2	Lagran		
			Thorse is the state of the state

STORMWATER RUNOFF DISPOSAL

LORD HOWE ISLAND BOARD

ELECTRICAL SUPPLY

NOTIFICATION OF PROPOSED ADDITIONS AND/OR ALTERATIONS TO EXISTING ELECTRICAL SUPPLY

RTICULAR	POI S OF PROPOSED	RTION NO		SERVICE NO	o. <u>Met</u>	e :280
LIGHTIN	IG POINTS	GP	o's	The state of the s	ER APPARA	
NO.	WATTS	SINGLE	DOUBLE	TYPE	NO.	WATTS
24	10-15W	0	20	Solar Hw)	1	2.4KW
	1 2	ř.	7 9 1 1 1			
					7 1 1	-
					····	
	1 . 41	1./	6	,		
7	7					
			chente lieut p	os itions	m, r	nove

Lorhiti House, LORD HOWE ISLAND

Drawing No.	Drawing Name
DA-00-03 Images	
DA-00.1	Register, Location Map, Legend
DA-00,2	Images
DA-02.1	Existing Site Plan - 1:500
DA-02.2	Existing Ground and First Floor Plan
DA-02,3	Existing Roof Plan
DA-02.4	Existing Elevations
DA-02.5	Proposed Site Plan - 1:500
DA-02.6	Proposed Ground and First Floor
DA-02.7	Proposed Roof Plan
DA-02.8	Proposed Elevations
DA-02.9	Proposed Elevations
DA-02.10	Existing and Proposed Floor Area
DA-03,1	Proposed North Elevation
DA-03.2	Existing & Proposed Floor Area





SLIE	Date	Description
Α	02/01/2024	Preliminary Plans
В	04/01/2024	Preliminary Plans
С	15/01/2024	Preliminary Plans

Project	Josh Owens Lorhiti House, LORD HOWE ISLAND
Drawing Name	Register, Location Map, Legend
Project Number	2401
Drawing No.	DA-00.1






Е	22/01/2024	Preliminary Plans
D	16/01/2024	Preliminary Plans
berre	Dava	Description

ans
3ITE
ans

Project	Josh Owens Lorhiti House, LORD HOWE ISLAND
Drawing Name	Images
Project Number	2401
Drawing No.	DA-00.2




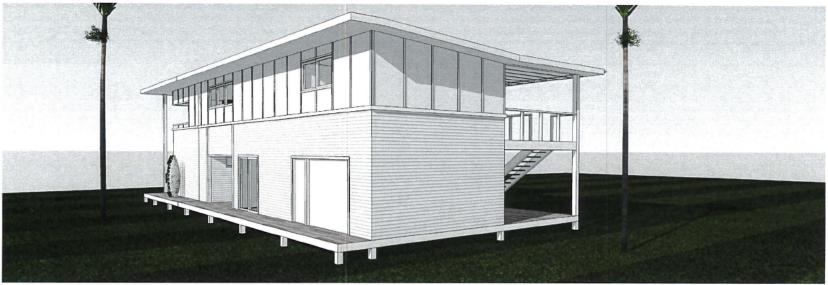

E	22/01/2024	Preliminary Plans
D	16/01/2024	Preliminary Plans

		С
4 Preliminary Pla	04/01/2024	В
4 Preliminary Pla	02/01/2024	А
4 Preliminary Pl	02/01/2024	А

Project	Josh Owens Lorhiti House, LORD HOWE ISLAND
Drawing Name	Images
Project Number	2401
Drawing No.	DA-00-03

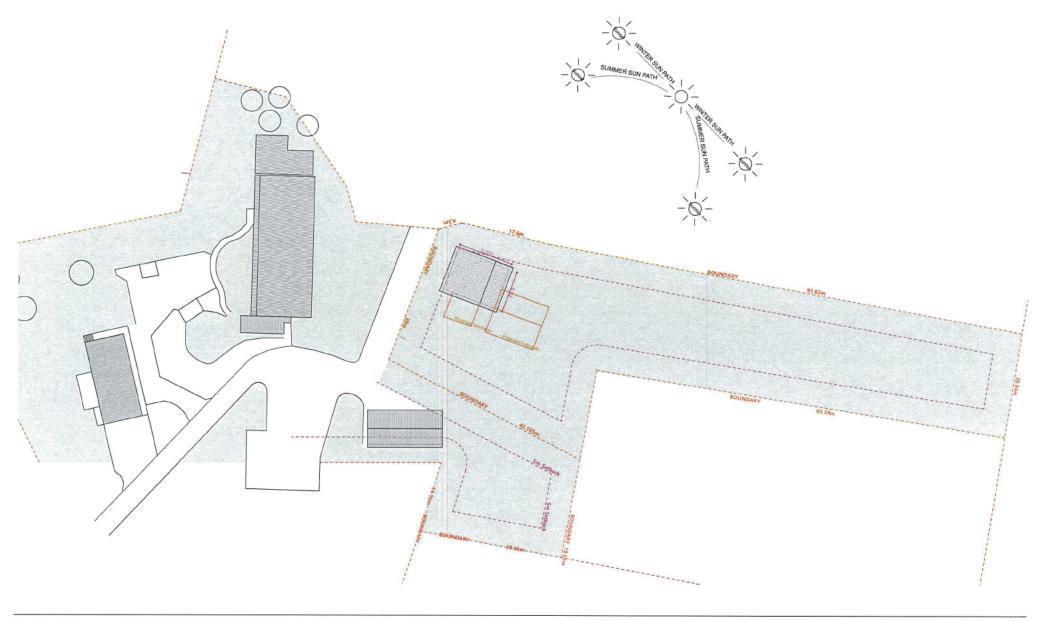



Scale 1:500 @ A3


NOT FOR CONSTRUCTION


E	22/01/2024	Preliminary Plans
D	16/01/2024	Preliminary Plans
Issue	Date	Description

С	15/01/2024	Preliminary Plans
В	04/01/2024	Preliminary Plans
А	02/01/2024	Preliminary Plans
	Date	Description

Project	Josh Owens Lorhiti House, LORD HOWE ISLAND
Drawing Name	Existing Site Plan - 1:500
Project Number	2401
Drawing No	DA-02.1

© Copyright - All rights reserved. No part of this design to be altered or reproduced visitious written permission

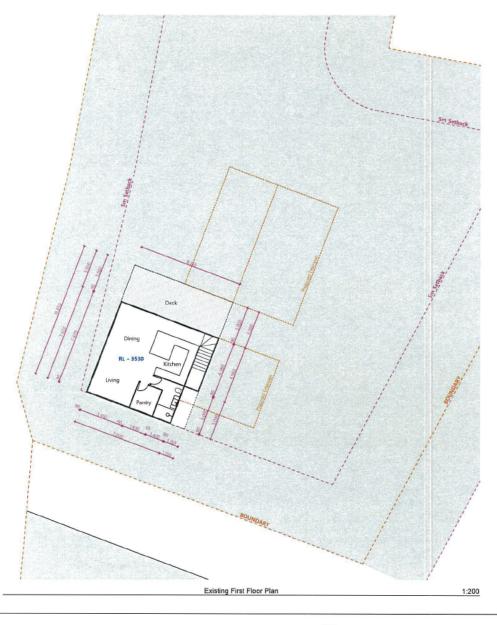

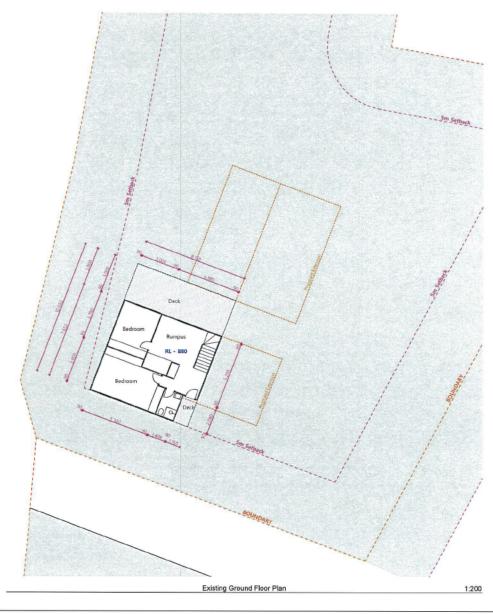




Scale 1:200 @ A3 & 1:100 @ A1 NOT FOR CONSTRUCTION

E	22/01/2024	Preliminary Plans
D	16/01/2024	Preliminary Plans
SSLIP	Date	Description

С	15/01/2024	Preliminary Plans
В	04/01/2024	Preliminary Plans
А	02/01/2024	Preliminary Plans

Project	Lorhiti House, LORD HOWE ISLAND Existing Ground and First Floor Plan	
Drawing Name		
Project Number	2308	
Drawing No.	DA-02.2	

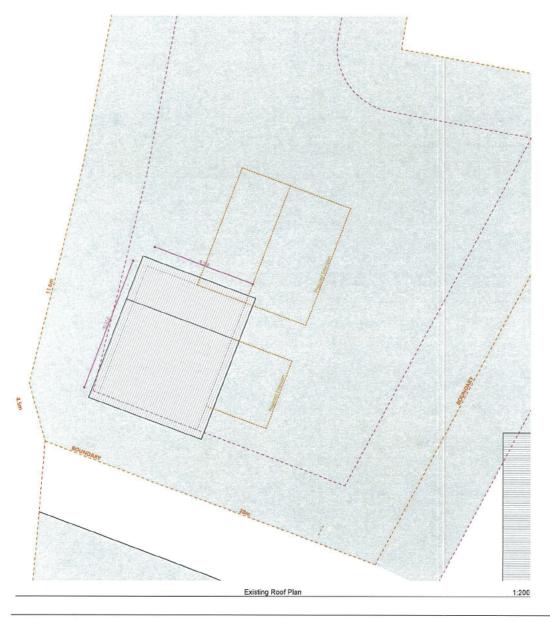







E	22/01/2024	Preliminary Plans
D	16/01/2024	Preliminary Plans
sue	Date	Description

91.92	Date	Description
Α	02/01/2024	Preliminary Plans
В	04/01/2024	Preliminary Plans
С	15/01/2024	Preliminary Plans

Project	Lorhiti House, LORD HOWE ISLAND Existing Roof Plan	
Drawing Name		
Project Number	2308	
Drawing No	DA-02.3	

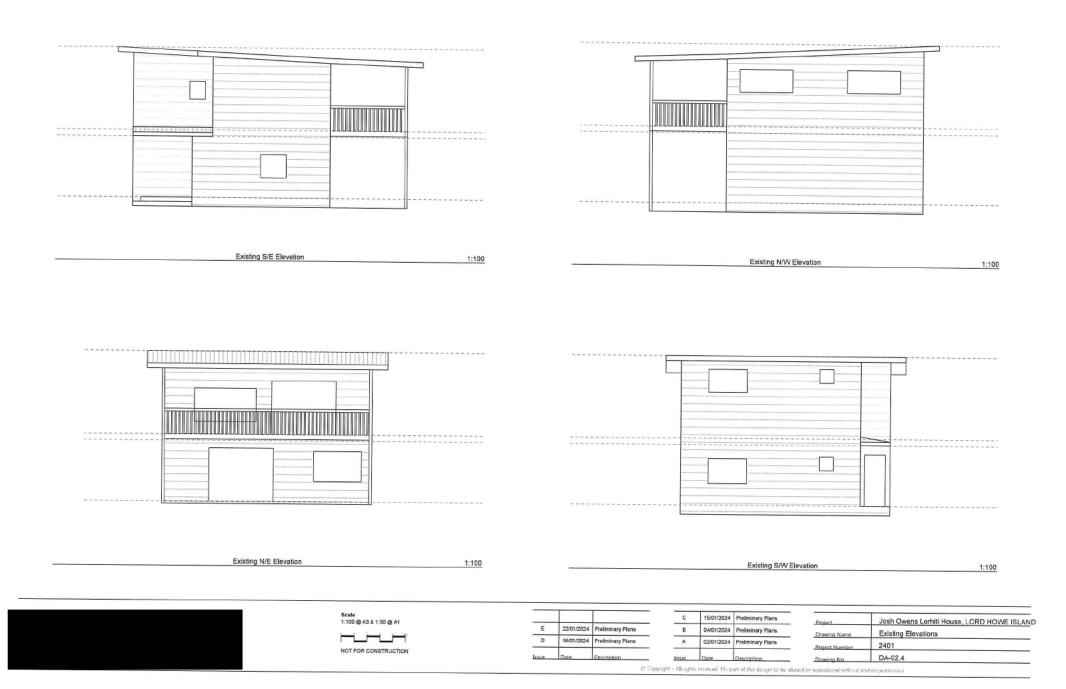

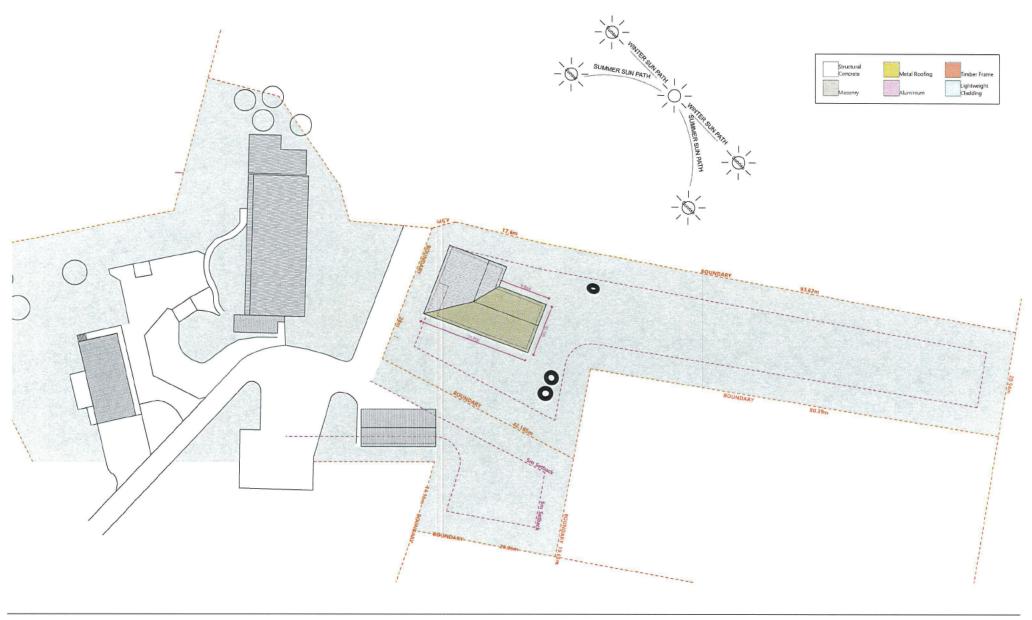



Scale 1:500 @ A3

NOT FOR CONSTRUCTION


E	22/01/2024	Preliminary Plans
D	16/01/2024	Preliminary Plans

С	15/01/2024	Preliminary Plans
В	04/01/2024	Preliminary Plans
Α	02/01/2024	Preliminary Plans
rue	Date	Description

Project	Josh Owens Lorhiti House, LORD HOWE ISLAND
Drawing Name	Proposed Site Plan - 1:500
Project Number	2401
Drawing No.	DA-02.5

© Copyright - All rights reserved. No part of this design to be altered or reproduced visitious written permission



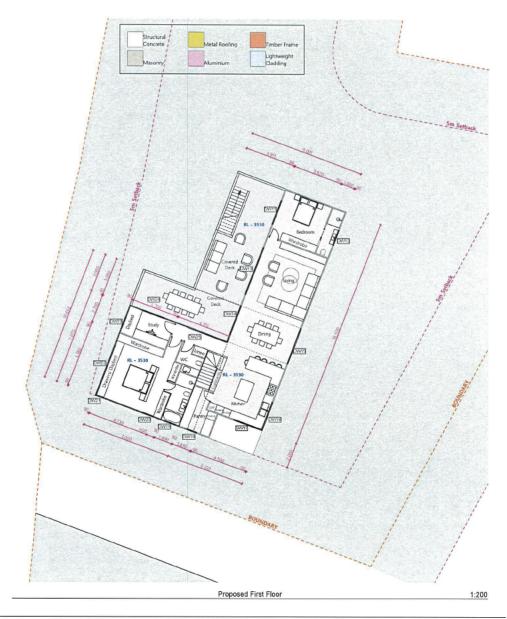




Scale
1:200 @ A3 & 1:100 @ A1

NOT FOR CONSTRUCTION

E	22/01/2024	Preliminary Plans
D	16/01/2024	Preliminary Plans
GELLER	Date	Description

C	15/01/2024	Preäminary Plans
В	04/01/2024	Preliminary Plans
A	02/01/2024	Preliminary Plans
	D. C.	Description.

Project	Lorhiti House, LORD HOWE ISLAND
Drawing Name	Proposed Ground and First Floor
Project Number	2308
Drawing No.	DA-02.6

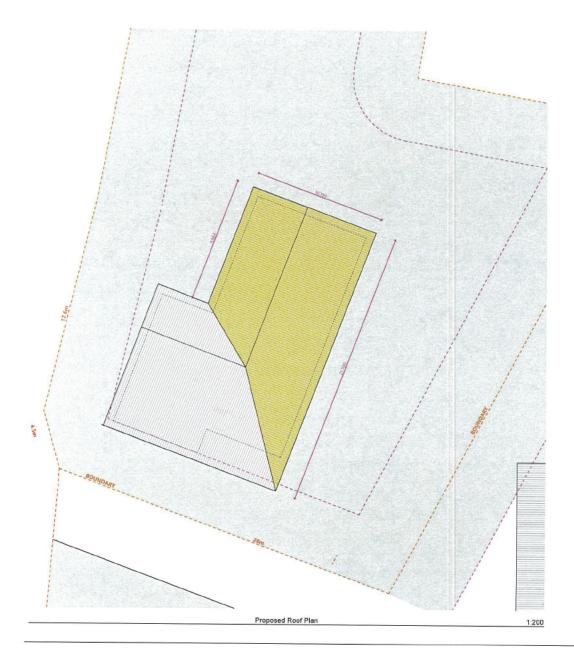







Е	22/01/2024	Preliminary Plans
D	16/01/2024	Preliminary Plans
	Date	Description

Α	02/01/2024	Preliminary Plans
В	04/01/2024	Preliminary Plans
С	15/01/2024	Preliminary Plans

Project	Lorhiti House, LORD HOWE ISLAND
Drawing Name	Proposed Roof Plan
roject Number	2308
Drawing No	DA-02.7

C Copyright - All rights received. No part of this design to be oftened or reproduced without written permission



Proposed S/E Elevation

1:100





Proposed N/W Elevation

1:100

Scale				-	С	15/01/2024	Preliminary Plans	Project	Josh Owens Lorhiti House, LORD HOWE ISLAND
1:100 @ A3 & 1:50 @ A1	E	22/01/2024	Preliminary Plans		В	04/01/2024	Preliminary Plans	Drawing Name	Proposed Elevations
	D	16/01/2024	Preliminary Plans		Α	02/01/2024	Preliminary Plans	Project Number	2401
NOT FOR CONSTRUCTION	Issue	Date	Description	Iss	ue	Date	Description	Drawing No.	DA-02.8
			@ So	pynght - Al	li rights r	elerved No p	ant of this design to be aftere	d or reproduced without will	ten permission



Proposed S/W Elevation

1:100





Scale
1:100 @ A3 & 1:50 @ A1
-
NOT FOR CONSTRUCTIO


E	22/01/2024	Preliminary Plans
D	16/01/2024	Preliminary Plans


C	15/01/2024	Preliminary Plans
В	04/01/2024	Preliminary Plans
Α	02/01/2024	Preliminary Plans

Project	Josh Owens Lorhiti House, LORD HOWE ISLANI
Drawing Name	Proposed Elevations
Project Number	2401
Drawing No.	DA-02.9

© Copyright - All rights reserved. No part of this design to be altered or reproduced without written permission.

Proposed Floor Area = 288m2

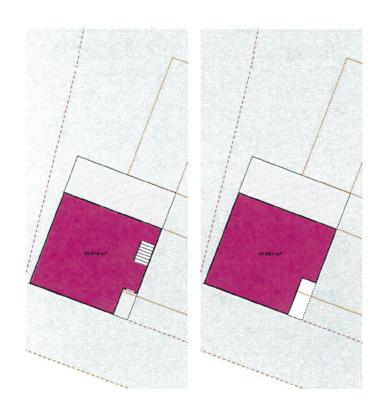

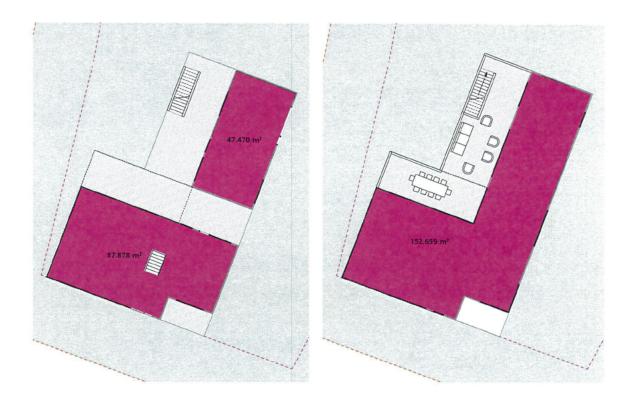



E 22/01/2024 Preliminary Plans
D 16/01/2024 Preliminary Plans

С	15/01/2024	15/01/2024 Preliminary Plans	
В	04/01/2024	Preliminary Plans	
Α	02/01/2024	Preliminary Plans	
	2000	Description	

Project	Lorhiti House, LORD HOWE ISLAND
Drawing Name	Existing and Proposed Floor Area
Project Number	2308
Francisco Min	DA-02.10

NOT FOR CONSTRUCTION

Josh Owens

Waste water Irrigation

Technical Proposal for the Relocation of irrigation field

Project Overview:

We propose the relocation of an existing waste water irrigation field. The original waste water plan submitted in 2009 was when the Josh Owens dwelling was on Lorhiti's block. Since then, the block has been subdivided with land aquired from Darrin Nobbs. This project aims to provide sustainable and environmentally responsible wastewater management solutions while meeting the specific needs of the Lord Howe Island Boards's On-Site Wastewater Management Strategy LHIB OWMS. A proposed extension of the existing dwelling is being submitted changing from 2 bedrooms to 4. The current system is a Biolytix BF6 wastewater treatment capable of efficiently handling one private household, with a limit of 1600L per day. This was installed with the new dwelling in 2009.

Project Scope:

The daily hydraulic load of effluent to be treated for the entirety of the property is 600lt per day. This is calculated by the following flow rates:

Source	Number	L/Day.Person	Total	
Existing dwelling	3EP	120	360	
Proposed extension	5EP	600	600	
			600	

1. Location:

Proposed location is a 400m2 grid located in the rectangular section between Darrin Nobbs and vacant Crown land portion 79. Allowing for a 5m buffer from boundaries the proposed field is 11m x 36m. A letter from Darrin Nobbs has been attached in the proposal giving permission to install the irrigation field within 20m of his building.

2. System Design:

The existing Biolytix BF6 was installed in 2009. The Design and installation of this wastewater treatment system has been approved by the LHIB.

Capacity: Biolytix BF6 treatment systems have a capacity of 1600L/day

System Type: Biolytix BF6 treatment systems are an enhanced trickling filter process which mimics a natural soil habitat

Effluent Quality: The following table outlines the effluent quality of the Biolytix BF6 systems

AS Required testing	Average Results	% Reduction	
---------------------	-----------------	-------------	--

Biochemical Oygen	<10mg/l	0.3 mg/l	99.20%
Demand			
Total Suspended	<10mg/l	1 mg/l	98.56%
Dolids			
E.Coli	<10cfu/100ml	0.80 cfu/100ml	99.99%
Total Nitrogen	N/A	38.7 mg/l	54.70%
Total Phosphurus	N/A	8.9 mg/l	24.74%
Maximum Hydraulic	N/A	1600L per day	N/A
load			

- Odour Control: Implement odour control measures to ensure a pleasant environment.
- Monitoring: Engage a suitable Biolytix technician to monitor the system in accordance with the LHIB OWMS.

3. Regulatory Compliance:

Waste water irrigation field installed on Lord Howe Island must be installed according to the LHIB OWMS.

4. Site Assessment and Technical Calculations:

Private Household

The total hydraulic load coming from the dwelling is calculated as per table shown below

Source	Number	L/Day. Person	Total
4 bedroom house	5EP	600	600

5. Irrigation areas and soil types

The irrigation areas have a ground type of sand and is proposed to be located within both Significant Native Vegetation and Exotic Gardens. A soil sample was provided to the LHIB to confirm soil types. The following tables outline the information that was used to determine the irrigation areas of the systems.

Vegetation type:

The vegetation type proposed is Significant vegetation and exotic gardens as such the below highlighted has been used.

Vegetation type	Nitrogen	Phosphorus	units
Kikuyu	260	25	kg/ha/yr
Significant natural vegetation	200	20	kg/ha/yr
Coastal rainforest	200	20	kg/ha/yr
Kentia palm plantation	200	20	kg/ha/yr

The soil type is sand as such the below highlighted figures have been used

LHI Soils	P-sorption	units
Sand	170	mg/kg
Calcareous earth	400	mg/kg

Volcanic soil	700	mg/kg	
SOIL BULK DENSITY	SOIL BULK DENSITY		
LHI Soils	Bulk Density	units	
Sand	1.8	g/cm ³	
Calcareous earth	1.6	g/cm ³	
Volcanic soil	1.4	g/cm ³	

Hydraulic loads, soil samples and proposed irrigation areas were sent to the LHIB's Senior Manager - Infrastructure and Engineering to determine the size of the irrigation areas required. It was determined that;

Irrigation area -- 385 meters squared

In both cases Phosphurus annual crop uptake is the limiting factor. All four documents (Water Balance and Nutrient Balance) can be found within this document.

As per the LHIB OWTS irrigation areas are to have a maximum area of 400m2. A diagram of the proposed installation can be found within this document outlying these areas.

5. Engineering and Design:

To complete this proposal a plumber was engaged to propose best layout and installation

6. Installation:

The wastewater system will be expertly installed by a highly experienced team of technicians guaranteeing technical excellence throughout the installation process. Installation will be synchronized with board approvals.

7. Maintenance and Monitoring:

A plumber will be engaged to provide ongoing maintenance and check. A high-level alarm is already on installed on the existing system.

8. Development Application (DA) Compliance:

We confirm that the existing wastewater treatment systems have been designed and engineered to fully satisfy the conditions specified in the Development Application (DA) for each site. Compliance with DA requirements is a fundamental aspect of our design and implementation.

We kindly request the possibility of out-of-session approval for the installation of this irrigation field of this system to expedite progress in line with the original Development Application (DA) ADD IN NUMBER.

9. New Septic Supplier and Superior Effluent Quality:

On-going testing on water quality

10. Special Consideration for Irrigational Area:

We acknowledge that the Local Environmental Plan (LEP) currently restricts the location of an irrigational area within Significant Native Vegetation. However, we propose that, subject to council approval, the irrigational area for treated effluent may be considered within Significant Native Vegetation areas if the council deems it environmentally viable and sustainable.

As stated earlier in this report part of the subject site and adjoining land are mapped Significant Native Vegetation (SNV).

The proposed irrigation areas will be partly located in these SNV mapped areas. We have submitted that due to site considerations such as built structure, driveways and access paths, slope, there are no feasible alternative areas to those identified as part of this development proposal. As reported elsewhere in this assessment, the LHIB have provided technical and environmental assessments supporting the proposed installations subject to the application of a number of requirements included in the recommendation of this report. The installation of this pipework on the surface within the SNV will not remove or damage any SNV as it only involves placement of the piping on the surface. Effluent will be pre-treated to ensure nutrient levels will not damage SNV. We are committed to working closely with the council to seek necessary approvals and ensure minimal environmental impact.

11. Conclusion:

Our proposal outlines the installation a new irrigation field on an existing system, approved by the LHIB. Technical calculations, including soil percolation rates and hydraulic loads, have been performed to ensure the systems are sized appropriately for each site's specific requirements. The involvement of a university student pursuing a Masters of Environmental Engineering adds expertise to the project.

We are committed to working closely with the council to explore options for the placement of the irrigational area within Significant Native Vegetation areas, subject to environmental considerations and council approval. We look forward to further discussing this proposal and working collaboratively to ensure the successful project implementation. Please do not hesitate to contact us for additional information or to schedule a site assessment.

Sincerely,

Josh Owens

JOSH OWENS PLUMBIN	IG
_	

13-1-24

Att: Lord Howe Island Board

Letter regarding drip-line irrigation for Josh Owens property, 78 Anderson Road, Lot Relocation of irrigation field

It has been advised I need to write a letter explaining the reason to have the proposed irrigation partially run in SNV. There are multiple reasons this is preferred to underground lawn irrigation. A part of the irrigation field will be in exotic gardens.

Once the building extension is complete, there will not be enough lawn area to install the irrigation field. The natural lay of the site slopes towards buildings on piers which with the addition of irrigation could promote ground water to these areas and damage structure integrity.

The lawn area has taken years to establish and maintain to a high standard. Running irrigation under the lawn area would require digging up sections of this lawn which would take a long time to repair.


In addition to this the cost is significantly higher to run irrigation under lawn rather than SNV. Instead of rolling lengths of pipe through vegetation and letting it get covered with leaves there would be huge labour costs added in order to trench under to lawn, as well as reinstate and maintain turf.

I hope this satisfies the Boards requirements.


Kind Regards,

Josh

Options analysis for wastewater systems proposed within SNV - Josh Owens

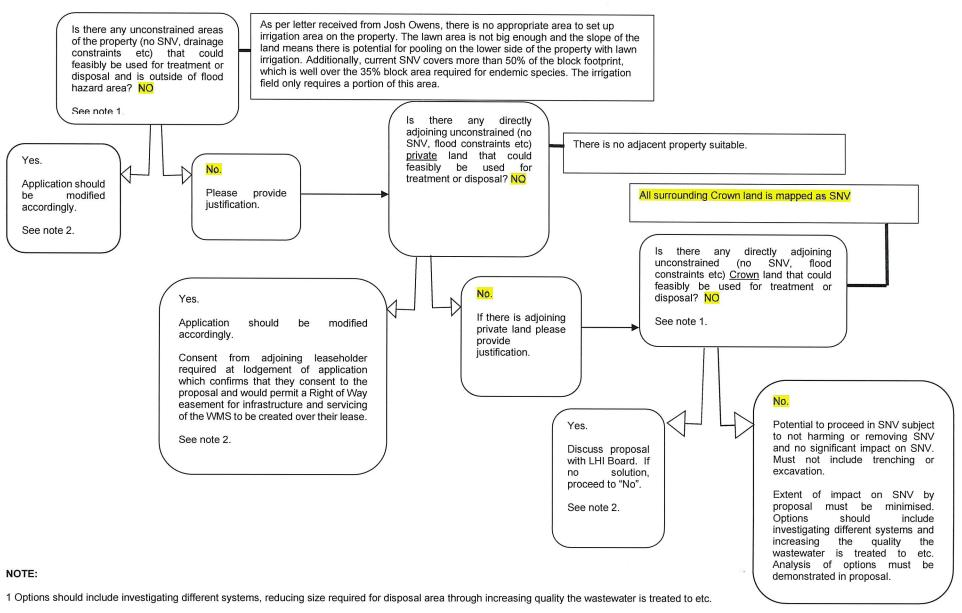

2 If a proposal is likely to affect threatened species, populations or ecological communities, or their habitats, a 7-part test must be prepared in accordance with Division 2 of Part 6 of the *Threatened Species Conservation Act 1995* and submitted with the application.

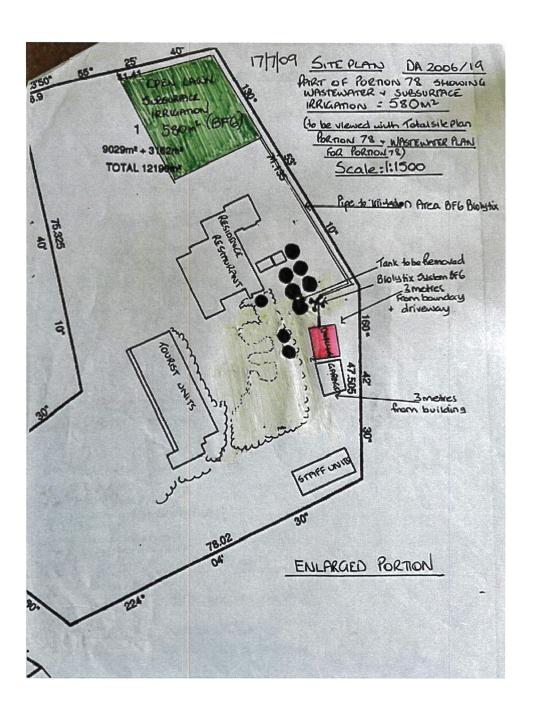

W/W6



To whom it may concern,

We understand Josh Owens is applying to extend on his house.


We have no issue; we give permission to Josh Owens to run an irrigation field within 20M of our dwelling.

If requiring any further information, please don't hesitate to contact us.


Kindest regards

Darrin Nobbs & Jennifer Walker

All Island Service Pty Ltd Ph: 02 6563 2025 E: <u>info@allislandservice.com.au</u> W: www.allislandservice.com.au

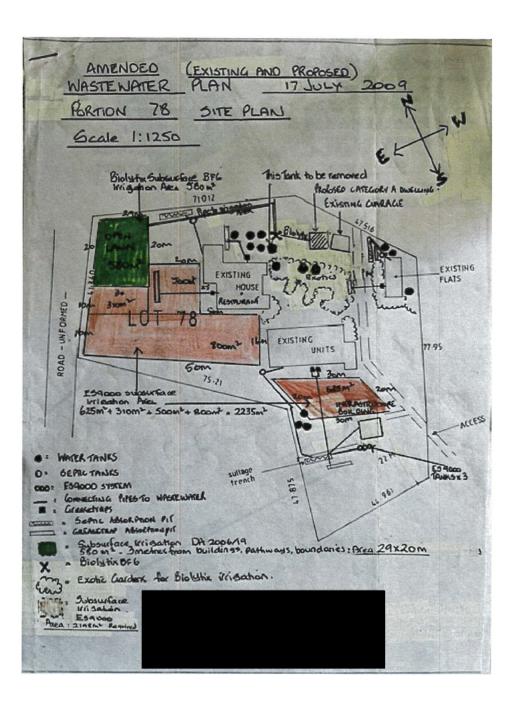

L MM

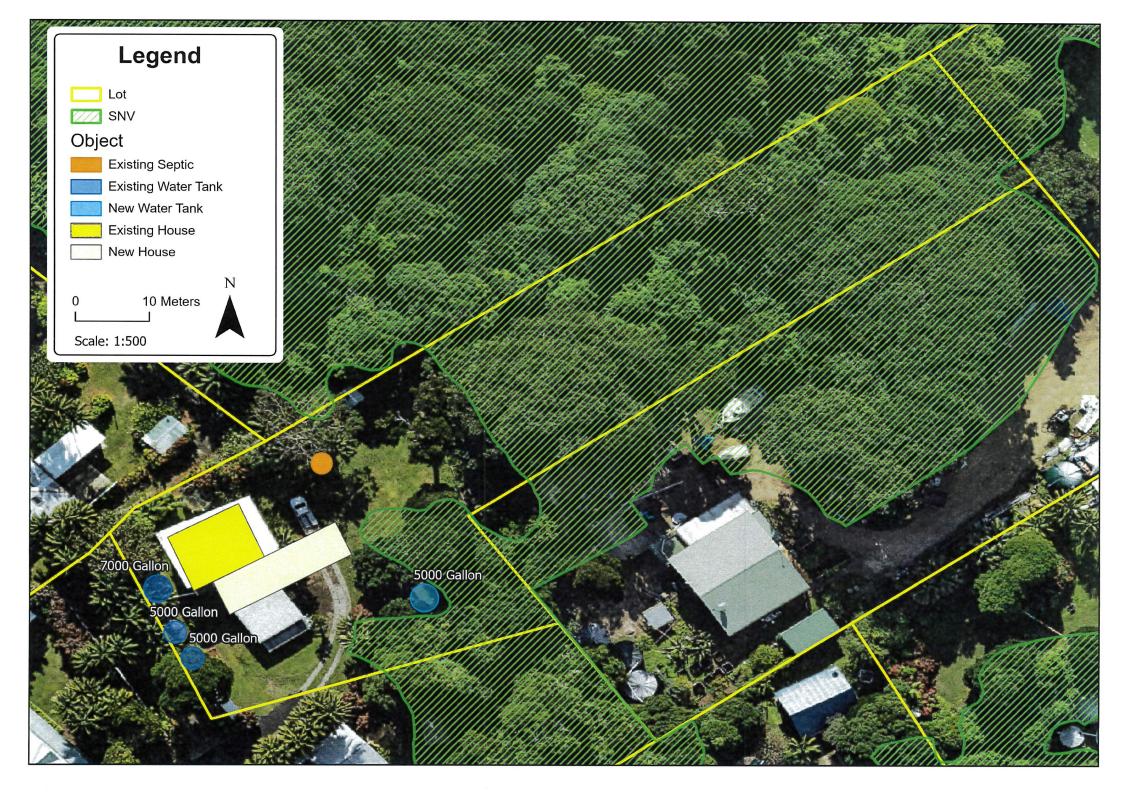

Vehicular ingress/egress to DP1202580/11, Lord Howe Island, NSW, 2898

Land Information

Lot: DP1202580/11

Perpetual Lease number: 2015.01

Leaseholder: Joshua Roylance Owens

Vehicular ingress/egress to DP1202580/11, Lord Howe Island, NSW, 2898

Access to this lot is via two existing Rights of Way.

- 1. Right of Way over Portion 74.
 - · Land is Vacant Crown Land
 - Shown as Part D in figure 1, highlighted in YELLOW.
- 2. Right of Way over DP1261010/2
 - Land is Perpetual Lease held by Fletcher Owens
 - Shown as Part C in figure 1, highlighted in BLUE.


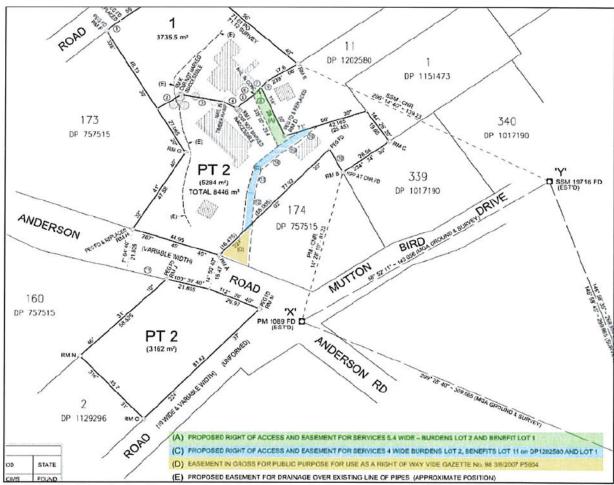


Figure 1. Extract from the Registered Plan for DP1261010, showing the proposed and existing accesses for DP1201580/11 and neighbouring lots. Full plan is visible in Appendix 1.

Figure 2 shows these existing Rights of Way as per the NSW Cadastral dataset.

Figure 2 (right). Easement access to DP1202580-11.
Easement is shown in pink, road is shown in blue, lots are shown in orange with white boundaries. Source: NSW Spatial Services Property Theme Dataset: https://portal.spatial.nsw.gov.au/server/rest/services/NSW Land Parcel Property Theme/FeatureServer

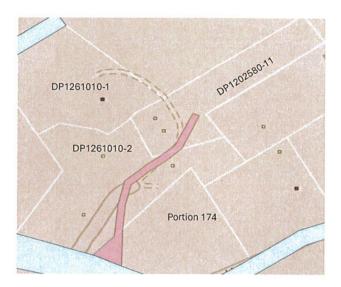

Right Of Way - Crown Land

The existing Right of Way over Crown Land Portion 174 was gazetted 5th July 2007:

LORD HOWE ISLAND ACT 1953

Notification of Reservation of Crown Land for a Public Purpose
IN pursuance of the requirements of the Lord Howe Island Act 1953, the land described hereunder be reserved for the public purpose for use as a right of way for access to Portion 78.

Part Portion 174 being the west most corner of the portion.

PHIL KOPERBERG, M.P., Minister for Climate Change, Environment and Water

Dated this 5th day of July, 2007.

Department of Environment and Climate Change
Sydney.

Source: page 5604, Government Gazette OF THE STATE OF NEW SOUTH WALES Number 98, Friday, 3 August 2007 (appendix 2).

The approved map associated with this gazette is below (figure 3), which shows the ROW in the west most corner of the Portion. This document is also attached to the Development Application as appendix 3.

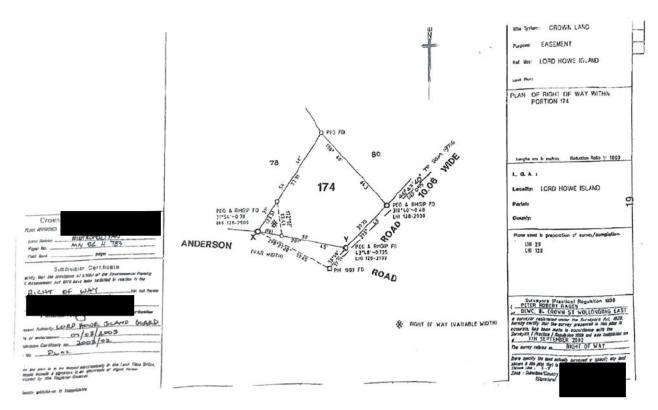


Figure 3. Right of Way over Portion 174, gazetted 2007.

Right Of Way - DP1261010/2

The existing Right of Way over DP1261010/2 is a condition on the lease over this lot, as per condition 20 from the "Lease in Perpetuity for the Purpose of Residence" (lease number 2021.02):

"20. THE lessee has the benefit of a Right of Access in terms of the wording of part 14 of schedule 8 of the Conveyancing Act 1919 but only within the surveyed boundaries shown on the plan DP1261010 registered 9th March 2020 held by the Board vide a copy of which is attached as a notation to this lease."

Figure 1 is an extract of plan DP1261010 showing these Rights of Access. A copy of the registered plan and the full lease conditions for lease 2021.02 are also attached to this application (appendix 1 and 4 respectively).

The registered plan for the subdivision also states:

"As per the registered plan of subdivision of Lot 10 in DP1202580 (creation of Lot 1 & 2 DP1261010), a proposed right of assess and easement for services 4 wide, burdens lot 2, benefits lot 11 on DP1202580 and Lot 1 (C)."

This plan was registered on 9/3/2020 & signed off by LHIB CEO Peter Adams.

Impact on Access for Neighbouring Lots

The proposed development footprint is well clear of all existing easements (figure 4), therefore the proposed development does not impact any existing Rights of Way or access routes for DP1202580/11 or neighbouring lots.

Access to DP1261010-1 (held by Diane Owens) is currently via a driveway to the west of DP1202580-11 (figure 4). This driveway is shown as Part A on the registered plans for the subdivision of 1261010, registered 9 March 2020 (figure 1, highlighted in green). This easement is wholly on DP1261010-2, so will be unaffected by the proposed extension on DP1202580-11.

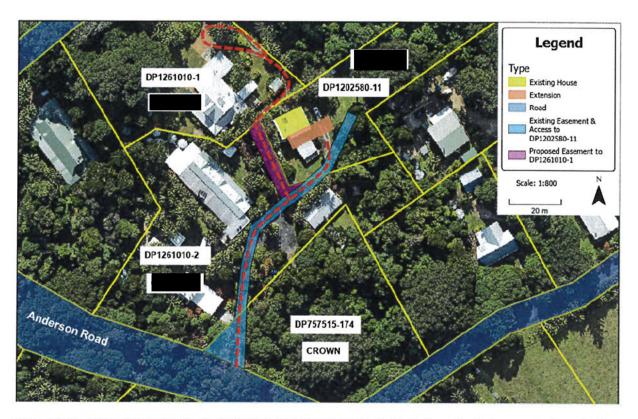


Figure 4. Imagery of vehicle ingress/egress for DP1202580-11 and neighbouring lots. Current vehicle access is shown by the red dotted lines.

Note: the proposed access (Part A) for DP1261010-1 (Diane Owens) was developed during the subdivision when DP1261010-1 & 2 were created and has been used as the primary access driveway to DP1261010-1 for the last decade. The current section of easement on DP1202580-11 neither extends to DP1261010-1, nor is it an accessway for DP1261010-1.