LORD HOWE ISLAND	BOARD		Date Received:
Development Applic	ation		
Section 4.12, Environmental Planni	ng and Assessment A	ct 1979	
Development Application No.:	DA2022.7.1 •	Date Lodged:	2022
 Use this form to apply for development co Erect, alter or demolish a building Change the use of land or a build Subdivide land; 	g or structure;	 Display an advertisement Any other development t from the Lord Howe Islar 	hat requires consent
	s 🗌 and fill out the section ermination. If you need h Other:	ons provided as appropriate. When help please phone or call the Board	your application has been
Name:Chad.Wilson			
Organisation:			
	Fa>	c	
Email:			
OWNER CONSENT Has Owner Consent been issued?	🕽 Yes 🗌 No	Owner Consent No.:	
IDENTIFY THE LAND YOU PROPOSE TO) DEVELOP		
Portion/Lot No.: 1	Depo	osited Plan No.: 1279044	
Lease No.: 2022.01			
Address:			

PROPOSED DEVELOPMENT

Describe the proposed development; give a detailed outline of what you are going to do. If it involves a building, indicated what it will be used for.

Proposed Tourist Accommodation alterations, additions and conversion of existing dwelling. Alterations to existing dwelling with two bedrooms and ensuites. Alteration second story, layout two bedrooms and ensuites to the existing building The second story will be added under the existing building. Conversion existing dwelling to tourist accommodation four bedroom and ensuites. Construction of new transit lounge and new laundry/ storage shed, construction of replacement residential dwelling and New waste water system.

Building Material: Concrete, timber, fibro Roofing Material: Corrugated iron.

PAST/PRESENT LAND USES

State the past known uses of the site	State the past known uses of the site:	Second dwelling.
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State the present known uses of the site: Second dwelling, NewTourist accommodation.

STAGED DEVELOPMENT

You can apply for development consent for only part of your proposal now, and for the remaining part/s at a later time.

Are you applying for development consent in stages? Yes X No If yes please attach:

- Information which describes the stages of your development;
- A copy of any development consents you already have which relate to your development.

PLANS OF THE LAND AND DEVELOPMENT

You need to provide a number of different plans that show what you intend to do. Step 4 of the Development Application Guide sets out which plans to provide and the details to include. Please submit 1 copy of the plans with the application. Please attach:

- A site plan of the land, drawn to scale;
- Plans or drawings of the proposal, drawn to scale and, where relevant;
- An A4 size plan of the proposed building and other structures on the site;
- A plan of any existing buildings (and uses), drawn to scale.

ENVIRONMENTAL EFFECTS OF YOUR DEVELOPMENT

To assess your proposal, we need to understand the impacts it will have. Depending upon the nature and scale of your proposal, you need to provide one or more of the statements listed below to explain the environmental effects of your proposal.

Is your proposal likely to cause a major environmental impact (e.g. designated development)?

- Yes
 - Please attach an environmental impact statement.
- No Please attach a statement of environmental effects (SEE).

Is your proposal likely to cause have significant effect on threatened species, populations, ecological communities or their habitats?

Yes

Please attach a species impact statement.

SUPPORTING INFORMATION

You can support your application with additional material such as photographs (including aerial photographs), slides and models to illustrate your proposal.

Please list what you have attached.

BASIX certificate, Cost estimate report, Council DA Checklist, Floor plans, Generated Pre-DA form, Form - Electricity - Application for Supply - New Installation, Form - Electricity - Application for Supply - New Installation 2, Statement of environmental effects, Wastewater Management Systems Checklist, Waste Water Effluent Irrigation Area, ACE-3000-Brochure.

NOTE: It will be necessary for you to place pegs showing the location of all building extremities and height of buildings within seven days of lodging your development application. These pegs will allows inspection by Board staff at an early stage of your development assessment.

APPLICATION FEE

For development that involves a building or other work, the fee for your application is based on the estimated cost of the development. If your development needs to be advertised to the public you may also need to include an advertising fee. Clauses 246 to 263 of the Environmental Planning and Assessment Regulation 2000 provide a schedule of fees.

NOTE: Fees will be calculated in accordance with Cordell's Building estimates and will form the basis for the fee. To save time and any delays in processing your application, please contact us if you need help to calculate the fee for your application.

Estimated cost of the development:	0.00	
Total fees lodged: \$2319.00	15/12/2022	eceipt No.:22774
APPLICANT/S OR APPLICANT'S AGENT DECL	ARATION	
Have you or any associated persons with a financ or given any gifts to any local Board Member or E		o years made any political donations
If you ticked yes please fill out a Political Donatio IMPORTANT NOTICE: It is an offence under the El		ole donations and gifts.
LEASEHOLDER AUTHORISATION – All leaseho		۱.
As the leaseholder/s of the above property, I/we	consent to this application.	
Signature:	Signature:	
Name: Chad Wilson	Name:	
Date:	Date:	
APPLICANT AUTHORISATION – The applicant/	s or the applicant's agent must sign the ap	plication.
apply for consent to carry out the development and correct. I also understand that, if incomplete requested within 21 days of lodgement.	described in this application. I declare that	all the information given is true
Signature:	Signature:	
Name: .Chad.Wilson	Name:	
Date:30/05/2022	Date:	
State the capacity in which you are signing if you	are not the applicant:	

PRIVACY POLICY

The information you provide in this application will enable us, and any relevant state agency, to assess your application under the Environmental Planning and Assessment Act 1979 and other applicable state legislation. If the information is not provided, your application may not be accepted.

If your application is for designated development or advertised development, it will be available for public inspection and copying during a submission period. Your application, and any attached plans will be published on the Lord Howe Island Board website. Written notification of the application will also be provided to the neighbourhood. You have the right to access and have corrected information provided in your application. Please ensure that the information is accurate and advise us of any changes.

Documentation provided with an application may also be accessed in accordance with the requirements of the Government Information Access (GIPA) Act 2009.

LODGEMENT

Before submitting your application, please ensure you have attached all the information the consent authority needs to assess your proposal. You can use the following checklist. Please place a cross in the box interval in the place attached:

Plans

- \mathbf{X} A site plan of the land all applications
- Plans or drawings of the proposal showing all dimensions all applications
- An A4 size plan of the proposed building and other structures on the site all applications
- A plan which is drawn to scale of all existing buildings.

Environmental effects

- An environmental impact statement for a designated development proposal and an electronic version of the executive summary
- A statement of environmental effects **required for all applications** that are not designated development
- An environmental report **if required under clause 42 of the LHI LEP 2010.** Contact the Board to see if you need to prepare an environmental report.
- A species impact statement
- A Basix Certificate The Building Sustainability Index (BASIX) applies to all residential dwelling types and is part of the development application process in NSW. A BASIX certificate **MUST** be obtained for "**BASIX affected development**". For further information please refer to <u>www.basix.nsw.gov.au</u>
- Electrical supply form must be completed (for new / alteration / addition to existing supply).

Staged development

- Information which describes the stages of the development
- A copy of any consents already granted for part of the development

Supporting information

Other material to support your application, such as photos, slides and models. *Please ensure any items listed as an Advisory Note as part of the Owner Consent approval have been addressed.*

Application fee

X Your application fee — required for all applications.

Where to lodge your application

You can lodge your completed application form, together with attachments and fees at the Lord Howe Island Board's office.

CONTACT DETAILS FOR YOUR INFORMATION

Lord Howe Island Board Bowker Avenue (PO Box 5) LORD HOWE ISLAND NSW 2898 Phone: 02 6563 2066 Fax: 02 6563 2127 Email: administration@lhib.nsw.gov.au Website: www.lhib.nsw.gov.au

Lord Howe Island Marine Park Authority

 Phone:
 02 6563 2359

 Fax:
 02 6563 2367

 Email:
 lordhowe.marinepark@npws.nsw.gov.au

 Website:
 www.mpa.nsw.gov.au

Department of Infrastructure, Planning and Natural

Resources – General Enquiries			
Phone:	02 9228 6111		
Email:	infocentre@dipnr.nsw.gov.au		
Website:	www.dipnr.nsw.gov.au		

Department of Infrastructure, Planning and Natural Resources – North Coast Office

49 Victoria Street (PO Box 6) GRAFTON NSW 2460 Phone: 02 6642 0622 Email: <u>northcoast@dipnr.nsw.gov.au</u> Website: <u>www.dipnr.nsw.gov.au</u> BASIX Certificate: <u>www.basix.nsw.gov.au</u>

LORD HOWE ISLAND BOARD Statement of Environmental Effects

A Statement of Environmental Effects must be completed and submitted with your development application, this is a requirement under the *Environmental Planning & Assessment Act 1979*. The Statement of Environmental Effects report explains the likely impacts of the development proposal taking into consideration relevant planning and environmental matters. If you require any clarification about what information needs to be included, please contact the Board's office on (02) 6563 2066.

Failure to submit a completed Statement of Environmental Effects report will result in the development application being rejected or incurring unnecessary delays before the application can be determined.

APPLICANT DETAILS	
Name:Chad wilson	
PROPOSED DEVELOPMENT	
Portion/Lot No.:1	Deposited Plan No.: .1279044
Lease No.: 2022.01	
Please tick the type/s of development you are ap	oplying for:
Dwelling House	Shed or Garage
Additions to Dwelling House	Dual Occupancy
Home Business	Additions to Dual Occupancy
Other – please describe:	
DEVELOPMENT DESIGN ATTRIBUTES	
EXISTING BUILDINGS	
	n the subject site? Existing structures located on the subject site (including their pining properties need to be shown on a site plan. Please show floor space.
Dwellings (4) Is existing with an in	nternal floor space of 150 m ² .
Dwelling (5) is existing with an inte	ernal floor space of 151 m ²
Building (6) is a proposed comme	rcial laundry and storage space 17.5 m ² .
Building (1) is a proposed transit r	room, that is 39 m ² internal space.
Iding (7) is propose spot to move t	he dwelling allocation to this building internal space 142 m
Building (3) is in existing shed inte	ernal square meterage is 50 m ² .

(8)New Waste water management system. Please see attached document.

DEVELOPMENT CONSENTS

If known, please list previous development and building approvals for the last 10 years which are considered relevant to this application. If necessary please consult Board staff.

DA Number	Development Description	Date of Consent
DA2016-30	Renovation on dwelling (1)	20/01/2016
DA2021.7	Subdivision/Boundry adjustment.	26/04/2021

OWNERS CONSENT

Please provide the reference number for the Owners Consent application. Please confirm that all conditions of owners consent have been met for this development application.

DEVELOPMENT REQUIREMENTS

DWELLINGS/RESIDENTIAL

Does your development comply with the **maximum gross floor area** and the **minimum dwelling area** (under Clause 20 & 23 LHI Local Environmental Plan 2010)? If yes, this must be demonstrated below.

Dwelling (1) internal floor space is 150m². Building (5) that is proposed area for dwelling (2) the structures internal space will be 142 m². Building (6) that is an existing shed 50 m². The three structures add up to 392 m². That is under the 400 m² allowed (under Clause 20 & 23 LHI Local Environmental Plan 2010)

Please specify if your development complies with the enlargements or extensions of a dwelling (under clause 27 LHI Local Environmental Plan 2010)? If yes, this must be demonstrated below.

(under clause 27 LHI Local Environmental Plan 2010) (1)(a) N/A (b) No SNV Will be removed. (c) there is over 50 % SNV. (2)(a) yes, it is a Dual occupancy. (b) yes, it is occupied by family. (c) it does not exceed 400 m². The domestic floor internal floor space is 392 m².

COMMERCIAL

Please specify if your development complies with the requirements in Clause 22 for tourist accommodation, staff

accommodation and commercial premises? If yes, this must be demonstrated below. (under clause 20 (4)(a) LHI Local Environmental Plan 2010) allows the dual block size to be 5000 m² My calculations is the block is 6773 m² -5000 m² = 1773 m² 15% = 265.95 m² of commercial space. All the buildings that erected for the commercial add up to 207 m². (b) there is over ...50 % SNV .(c) no building is getting erected where there is SNV. (d) there is a growing market on Lord Howe for smaller accommodation lodges. That offer more inclusive deals e.g. include charter vessel in price...... (2)N/A (3) N/A (4) The 8 tourist licenses are coming out of Oceanview Apartments (5)N/A... ALL BUILDINGS – MAXIMUM BUILDING HEIGHT

Please specify if your development complies with the maximum building height (under clause 29 LHI LEP 2010)? If yes, this must be demonstrated below.

On the commercial and dwelling buildings the ridge line does not exceed 7.5 m

.....

SUBDIVISION

Please specify if your development complies with the subdivision requirements under clause 21 of LHI LEP 2010? If yes, this must be demonstrated below.

.....N/A

ZONING

Does your development meet the objectives of the zone in which the site is in? Please provide how the development meets these objectives (clause 13-19 LHI LEP 2010).

Yes, Falls under the land zone 2 settlement.

.....

ENERGY EFFICIENCY

Does the development achieve the minimum BASIX requirements? To determine whether a BASIX certificate needs to be submitted with your application, please refer to <u>www.basix.nsw.gov.au/information/index.jsp</u>. Each development application for a residential dwelling and each development application for alterations and additions must have a BASIX certificate.

I have Completed my basix.Documents attached.

.....

BOUNDARY SETBACKS

How far is your development setback from the front boundary?

Every new building and dwelling is it at least 5 m or more back from every Boundary..

How far is your development setback from the side and rear boundaries?

Every new building and dwelling is it at least 5 m or more back from every Boundary..

Does the development comply with the Board's minimum setback requirements? If no, provide reasons why the development

should be supported?

Yes	

LANDSCAPING

Please specify if the development complies with the landscaping requirements for Zone 2 land (clause 33 LHI LEP 2010)? If yes, this must be demonstrated below.

There will be no clearing of any SNV, There will be some modifications to existing gardens and orchard.
LAND ADJACENT TO ZONE 7 OR 8 Please specify if your development complies with the requirements for land adjacent to Zone 7 or 8 (under clause 34 LHI LEP 2010)? If yes, this must be demonstrated below.
N/A
CONSTRAINTS
FORESHORE DEVELOPMENT Is your land within the foreshore development area? If yes, please how the development complies with foreshore developmen requirements (Clause 35 LHI LEP 2010).
N/A
AIRCRAFT NOISE Is your land subject to the Australian Noise Exposure Forecast? If yes, the development may need to include an Acoustic Repor with the application.
N/A
 FLOODING Is your land flood prone? If yes, what measures will be undertaken to ensure that: water is efficiently drained from your property without impacting upon any adjoining neighbours. the proposed development will not be adversely affected by flooding. N/A

HERITAGE

Is the development listed as a heritage item, located in a heritage conservation area or located adjacent to any known heritage item or archaeological site? If yes, a Statement of Heritage Impact and referral to NSW Heritage Branch may be required.

N/A			

SIGNIFICANT VEGETATION

Will the development require the removal of any vegetation in areas mapped as 'significant vegetation' in LHI LEP 2010 Sheet 3 as well as the proposed 'significant vegetation' map on exhibition? If yes, the proposed development may be prohibited.

No Significant vegetation will be removed.

RETENTION OF TREES AND LANDSCAPING

Will the development require the removal of any native trees and/or shrubs? If yes, please specify how many trees/shrubs need to be removed and indicate their location on the site/landscape plan.

Each of the red shapes that are marked on the SNV map. There 30 Kentia palm trees marked in each Section. Most of them can be re-planted in the shapes marked green on the SNV map. Besides the palms I was re-planting I was also going to other various Native species of plants in those areas.

RECOVERY PLANS AND HABITAT AREAS

Is the development consistent with approved Recovery Plans for the island? Does the development have any impacts on threatened species? If the answer to this question is yes then an Environmental Report, a seven part test or a Species Impact Statement may be required (Clause 42 of LHI Local Environment Plan 2010). It is important to remember that it is illegal to clear, modify, underscrub or remove any vegetation within areas of identified habitat.

N/A
Can the development be sited to retain existing vegetation? If no, explain why this is not possible.
Yes.

Do you intend to provide any landscaping to compensate for the removal of vegetation? If yes, please include a landscape plans specifying the species to be used. If no, please explain why supplementary landscaping is not necessary.

The landscaping areas are shown on the SNV map as green shape . Mainly landscaping with Kentia Palm's, Curly palms, Sally Woods, black butts, Hot Woods and any other native species that are common in the area.

VISUAL APPEARANCE

Explain how the external appearance of the development has been designed to take into consideration of the adjoining properties and character of the area.

The accommodation/commercial, will be a grey heritage colour for the roof and trimmings. The walls will be a white heritage colour. Hardwood timber deck. The second dwelling, The roof will be a SeaMist white colour and the trimmings. The walls will be a dark grey charcoal heritage colour. hardwood timber decks.

VISUAL AND ACOUSTIC PRIVACY

Describe how the development has been designed to reduce any possible impact on the visual or acoustic privacy of adjoining properties. Consider the use of screening, landscaping, offsetting windows and balconies.

Please see attached documents for answer.

.....

SOLAR ACCESS

Has the development been designed so that the main indoor and outdoor living spaces face north and east to take advantage of solar access? If yes, please specify the parts of the dwelling facing north and east.

The commercial/tourist accommodation one side of the roof faces to the north. That already has existing solar hot water. The second Dwelling will have poor solar access. Due to the way we had to outlay the building and dense native vegetation surrounding the dwelling.

VIEWS

Does the development obstruct any views from adjoining properties?

No.
Is it possible to site the development to minimise the obstruction of views? If no, explain why this is not possible.
N/A
PARKING AND TRAFFIC
How many on-site parking spaces are existing and how many will result from the proposed development?

Existing parking spots on the lease is two. There will be another two added to make a total of four parking spaces.

Does the development provide adequate manoeuvring areas without impacting on existing access and parking arrangements? If no, please justify why the development should be supported.

Yes.

.....

EARTHWORKS AND RETAINING WALLS

Does the site need to excavated or filled? If yes, specify the maximum retaining wall heights and type of construction. Retaining wall details need to be shown on the development plans.

With the construction of the access road there will be some minor excavation and retaining walls. The excavation will be mainly just removing The grass layer and flattening the axis. The accommodation car park. Will have a 400 mm high retainer wall at the north western side of it. That will be shown on the site plan. The other retaining wall is on the first level of the tourist accommodation. That won't exceed 1200 mm. Will be shown on drawings of dwelling.

WASTEWATER MANAGEMENT

Have you completed the Lord Howe Island Board Onsite Wastewater Management System checklist for Applicants and submitted with this application?

Yes, Have spoken to Kate Dignam About the Application.

STORMWATER RUNOFF DISPOSAL

How will excess stormwater runoff be disposed?

The natural fall of the land runs to a Gully that then runs into old settlement. The run-off from the tanks run into that gully. There is no issue with the stormwater run-off. **EROSION AND SEDIMENT CONTROL** What erosion and sediment control measure will be used to keep the soil on your site? Consider siltation fencing, diversion channels, stockpile protection, stormwater pit protection and gravel vehicle access. N/A Where will the erosion and sediment control measures be provided on-site? Please identify the location of the erosion and sediment control measures on the site plan. .N/A.... **OTHER CONSIDERATIONS** Are there any other particular measures proposed to mitigate and/or offset any significant impact caused by the development? N/A

Statement of environmental effects application for Chad Wilson.

Question: VISUAL AND ACOUSTIC PRIVACY

Answer.

The commercial sites (5 & 1) of the tourist accommodation building. The front side of the building that faces West. As a first story Veranda that acoustically will have dense vegetation in front of the Veranda to dull the noise. The second story Veranda will project the noise out into old settlement. The back Veranda on the main accommodation is well screened by dense garden and will also have a fence behind that Shield in the first dwelling on the property. The other part of the commercial is the transit room (1). That is designed to have all the acoustics from the building. It has been designed to reflect it to the west. That is dense vegetation and behind that is old settlement.

The second dwelling is in a naturally screened position on the block. That acoustically will catch a lot of the noise. There is a little bit of landscaping to do on the west side through to the North eastern side. But it is minor.

This is the SNV map, the red shapes areas (1,2) are where the trees are being removed from. 3, 4, 5 & 6 are existing structures. 7 is the proposed area for the second dwelling, that currently exists at location number 5. 8 is the proposed waste water system area.

The green Shaped areas, where I'm planning to move some of the trees to and plant out.






LOT NO. 1 DP 1279044	6773 SQM
BUILT AREA SUMMARY - COMMERCIAL	
EX. DWELLING TO BECOME GUEST HOUSE	152.5 SQM
PROP. TRANSIT LOUNGE	39 SQM
PROP. LAUNDRY/ STORAGE SHED	17 SQM
TOTAL COMMERCIAL	207 SQM
BUILT AREA SUMMARY - RESIDENTIAL	
EXISTING SHED	30 SQM
EXISTING DWELLING	150 SQM
PROP. DWELLING - 3 BEDROOM	142 SQM
TOTAL RESIDENTIAL	322 SQM

DRAWN

ISSUE DA

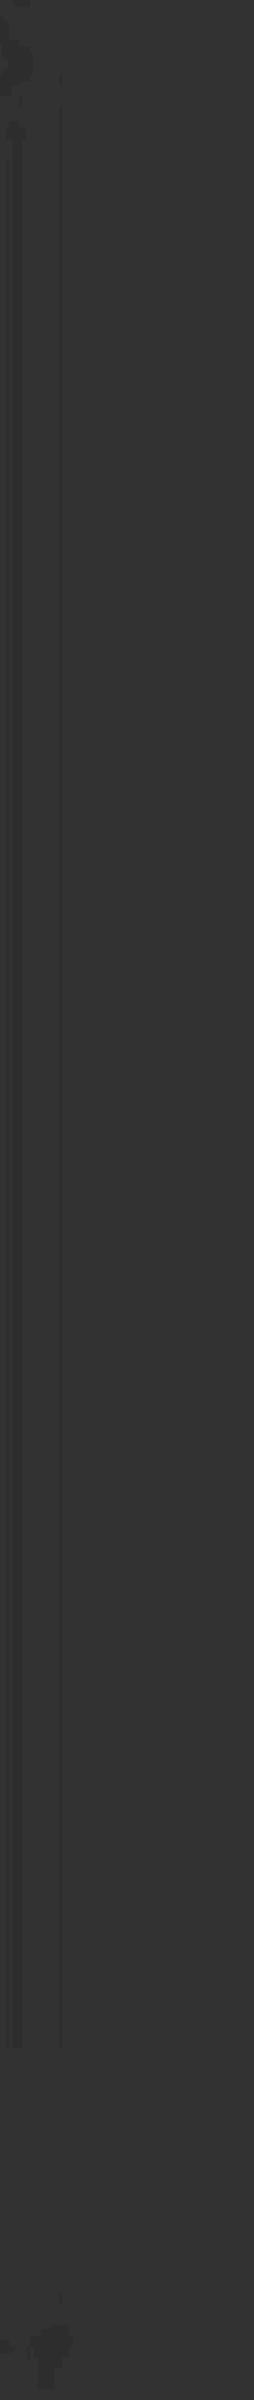





DRAWING REGISTER:

ISSUE DATE+REVISION

DESIGN DRAWINGS

DRWG NO.	DRWG TITLE	
035 DA-00	COVER PAGE A SUBMISSIC	ЛС
035 DA-01	PROPOSED SIT	ЛС
035 DA-02	GUEST HOUSE A SUBMISSIO	ЛС
035 DA-03	GUEST HOUSE	ЛС
035 DA-04	GUEST HOUSE. A SUBMISSIC	ЛС
035 DA-05	GUEST HOUSE A SUBMISSIC	ЛС
035 DA-06	GUEST HOUSE A SUBMISSIC	ЛС
035 DA-07	TRANSIT LOUN	ЛС
035 DA-08	TRANSIT LOUN	ЛС
035 DA-09	TRANSIT LOUN	NC
035 DA-10	DWELLING - PR	ЛС
035 DA-11	DWELLING - PR	ЛС
035 DA-12	DWELLING - PF	NC
035 DA-13	DWELLING - PF	ЛС
035 DA-14	DWELLING - PF	ЛС

APPENDIX

APP.1 SITE SURVEY



ROOM ON FIRE

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NOT FOR CONSTRUCTION

DA-00

DA




M M	- LINE DENOTING PREVIOUS BOUNDARY
	FREVIOUS BOUINDARI
	\bigwedge
	/
And	
C.S.	SNV MAPPING - DWELLING
	NEW DWELLING 3 BEDROOMS
	- NEW RETAINING WALL TO PROPOSED
FOWL SHELTER	WALL TO PROPOSED CAR PARK AS PER STRUCTURAL ENGINEER'S DETAIL
	- NEW GEOHEX
	DRIVEWAY AND CAR PARK
DRIVE	
DRIVE	
	- NEW SIGNAGE
	- NEW CONCRETE SLAB TO
	ENTRY OF EXISTING SHED
. 1 DP 1279044	6773 SQM

D. 1 DP 1279044	6773 SQM		
A SUMMARY - COMMERCIAL			
ling to become guest house	152.5 SQM		
ansit lounge	39 SQM		
JNDRY/ STORAGE SHED	17 SQM		
DMMERCIAL	207 SQM		
A SUMMARY - RESIDENTIAL			
SHED	30 SQM		
DWELLING	150 SQM		
/elling - 3 bedroom	142 SQM		
SIDENTIAL	322 SQM		

project no. 035 SCALE@A3 1:500

DRAWN CM

dwg no. DA-01

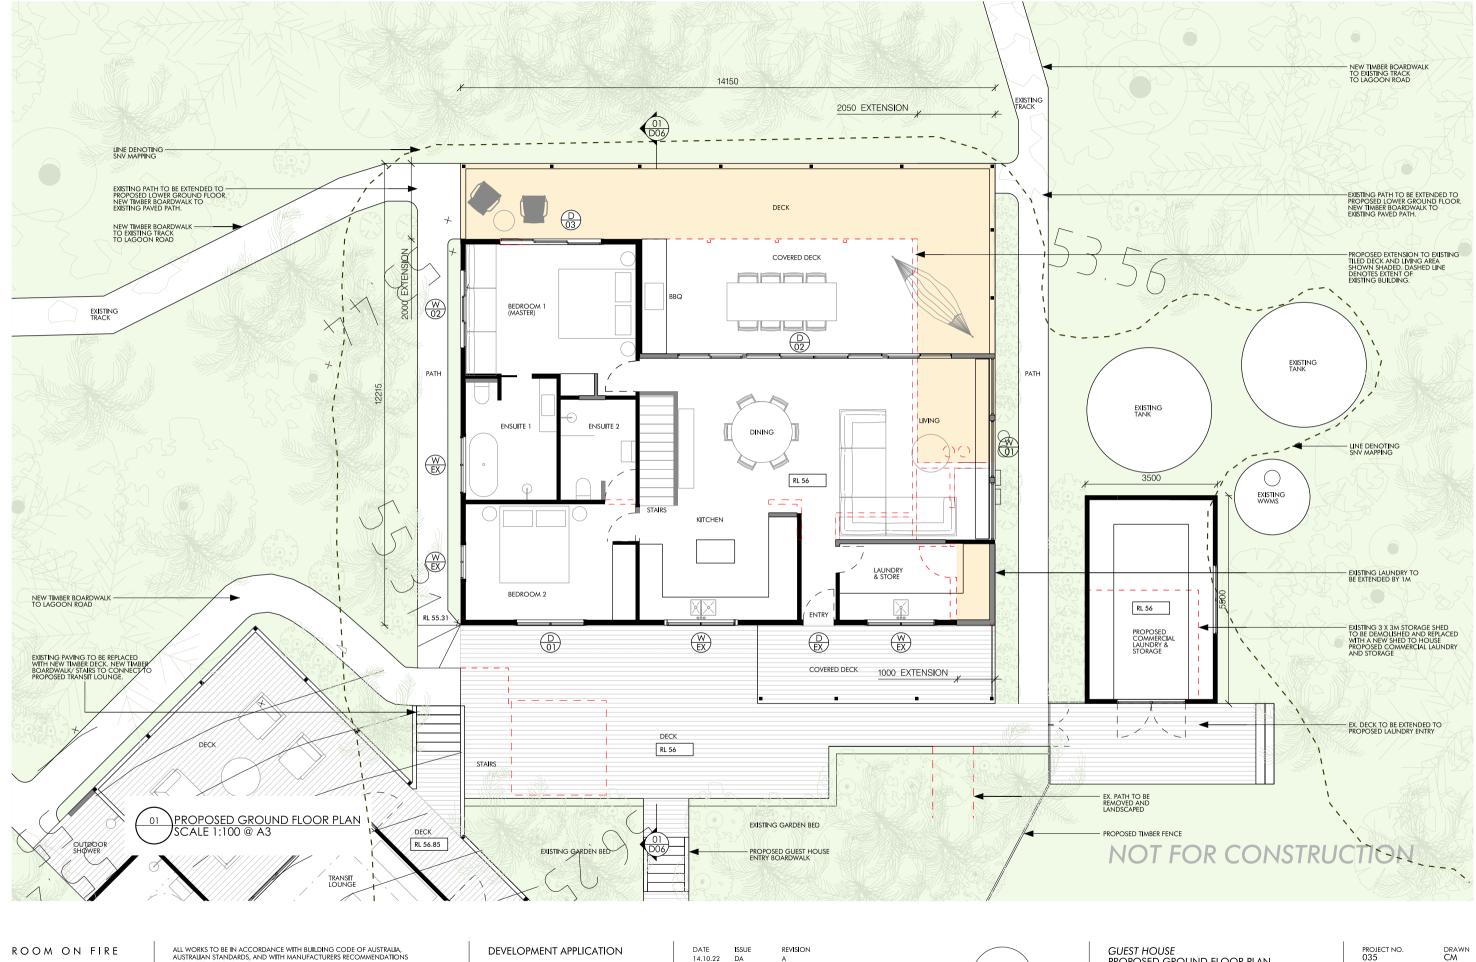

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LOT NO. 1 | DP 1279044 LEASE NO. 2022.01


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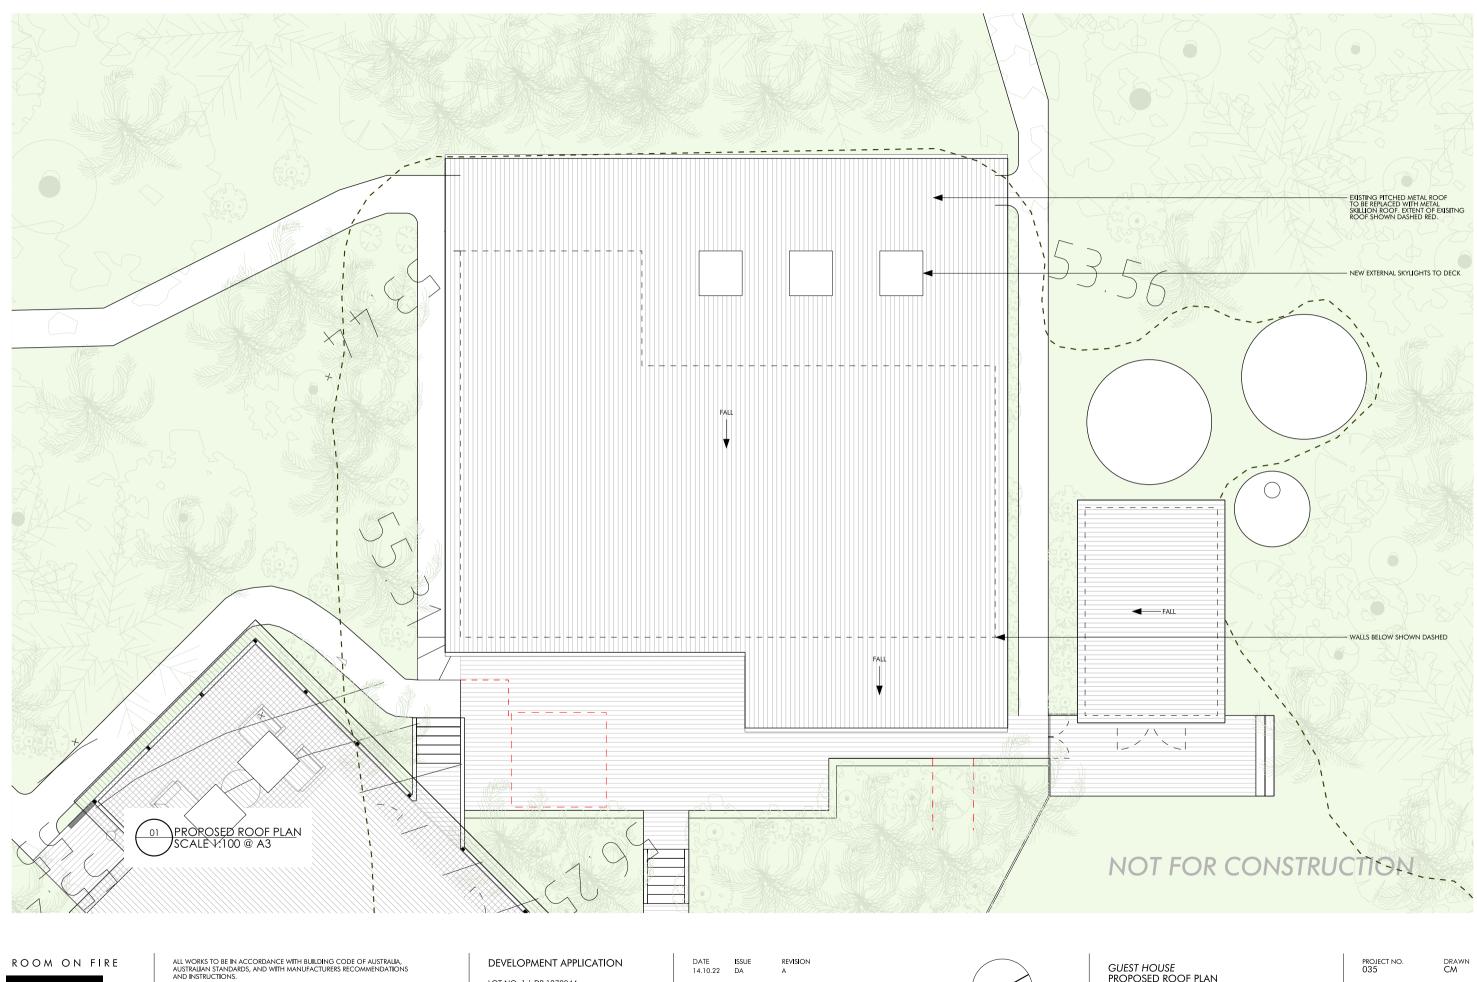


PROPOSED GROUND FLOOR PLAN

SCALE@A3 1:100

dwg no. DA-02



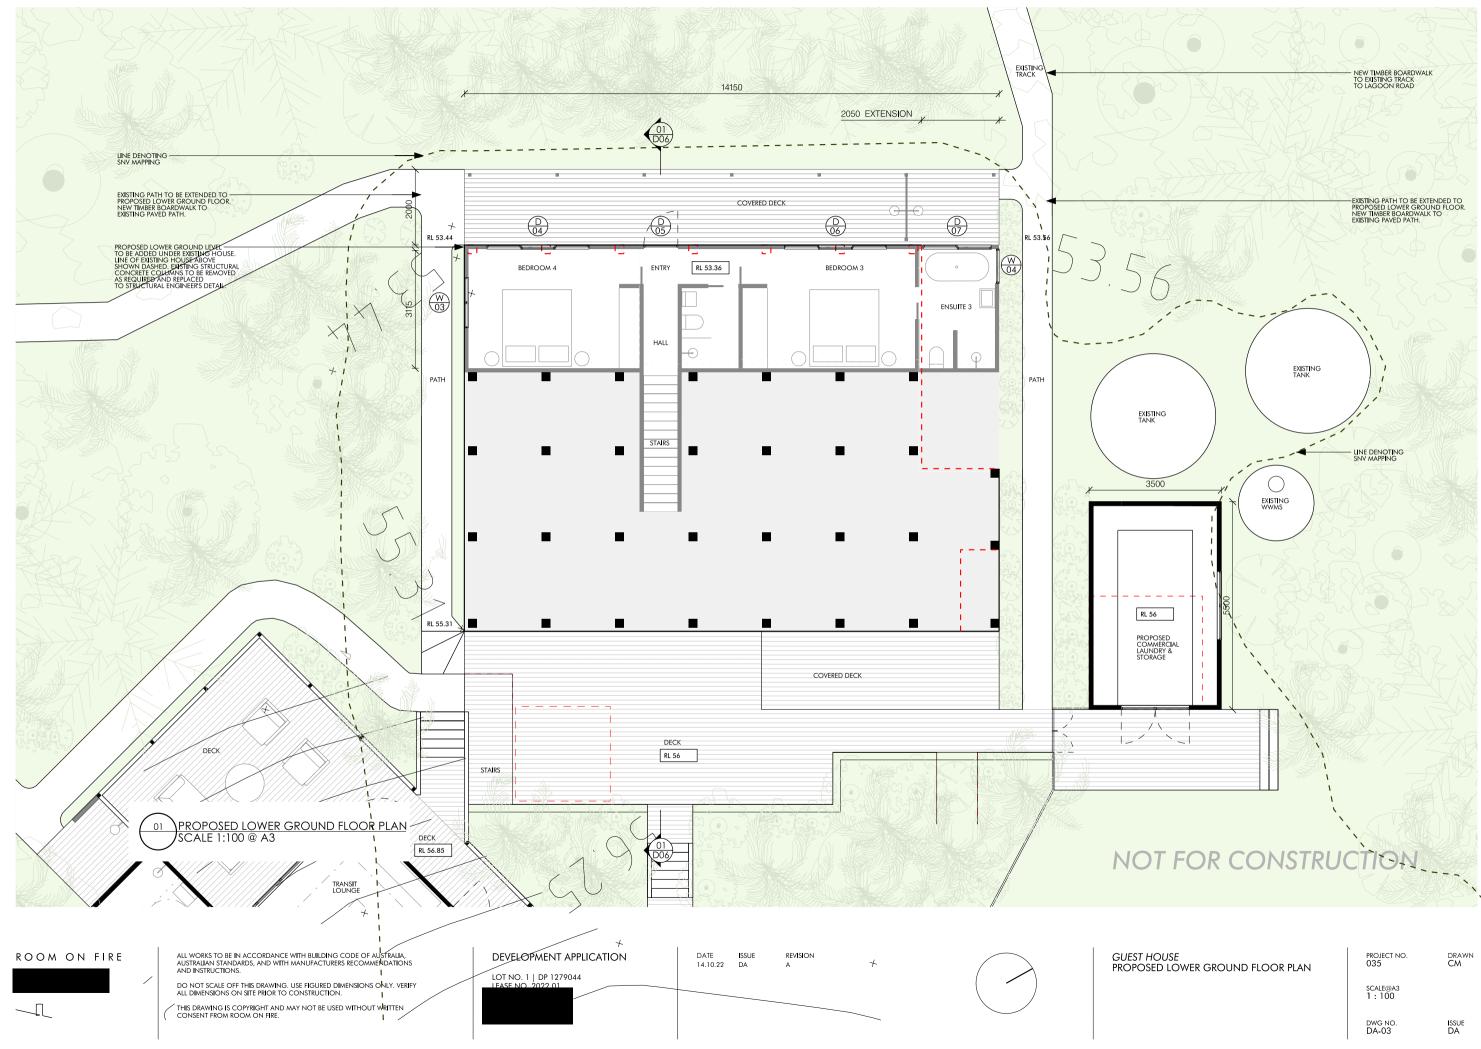

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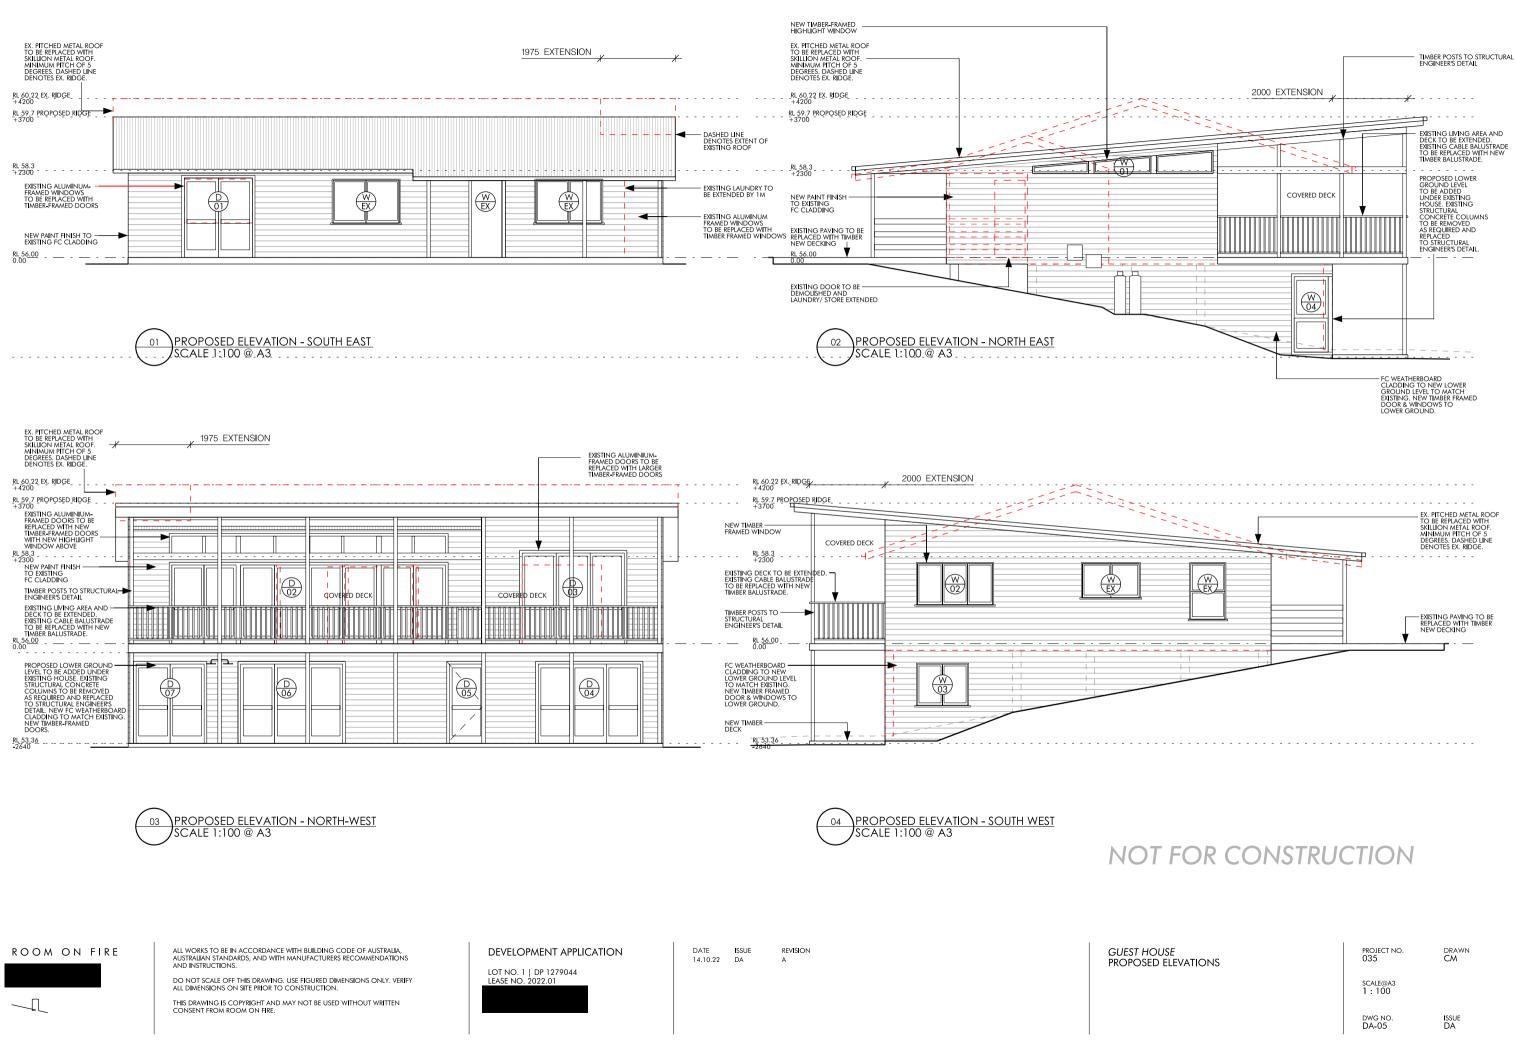
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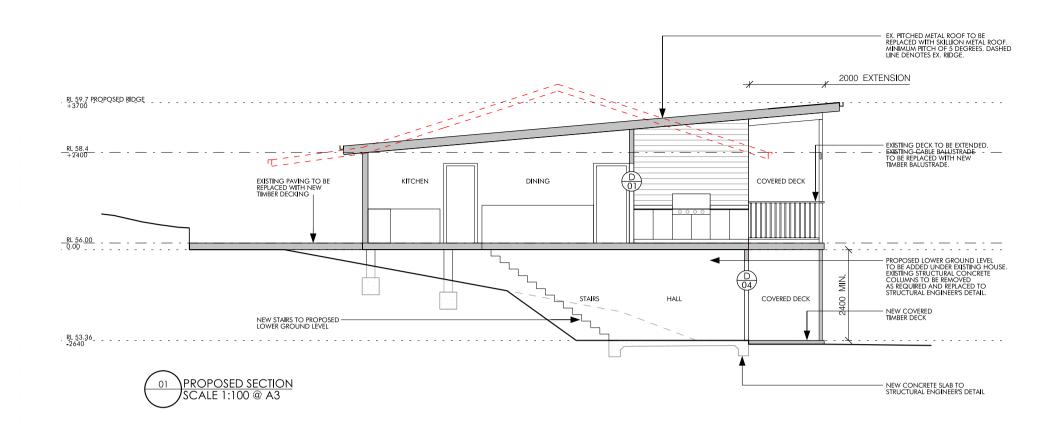
LOT NO. 1 | DP 1279044 LEASE NO. 2022.01



GUEST HOUSE PROPOSED ROOF PLAN

SCALE@A3 1:100 dwg no. DA-04





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DEVELOPMENT APPLICATION LOT NO. 1 | DP 1279044 LEASE NO. 2022.01

DATE ISSU 14.10.22 DA REVISION SSUE

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GUEST HOUSE PROPOSED SECTION


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project no. 035

DRAWN CM


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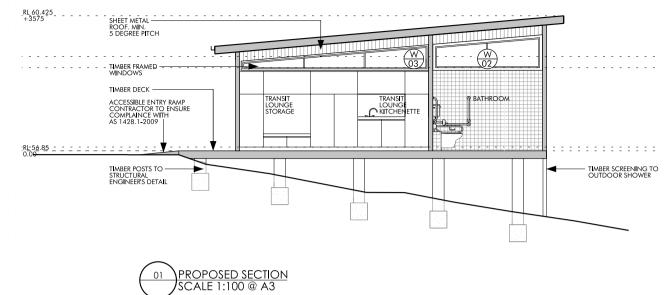
NOT FOR CONSTRUCTION



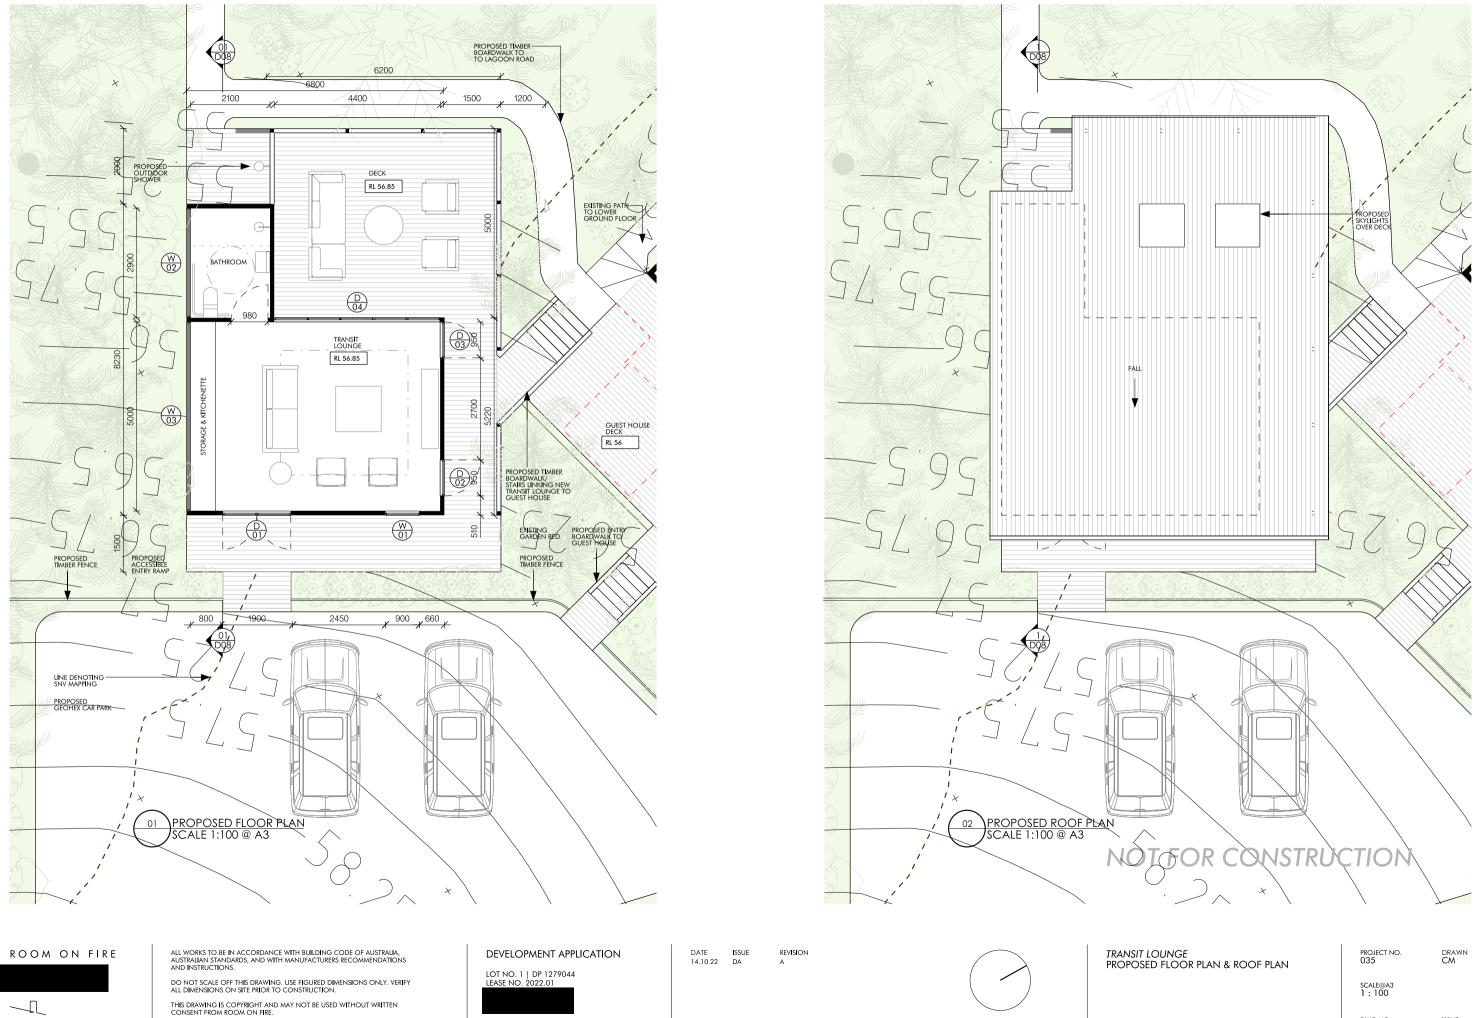

dwg no. DA-07



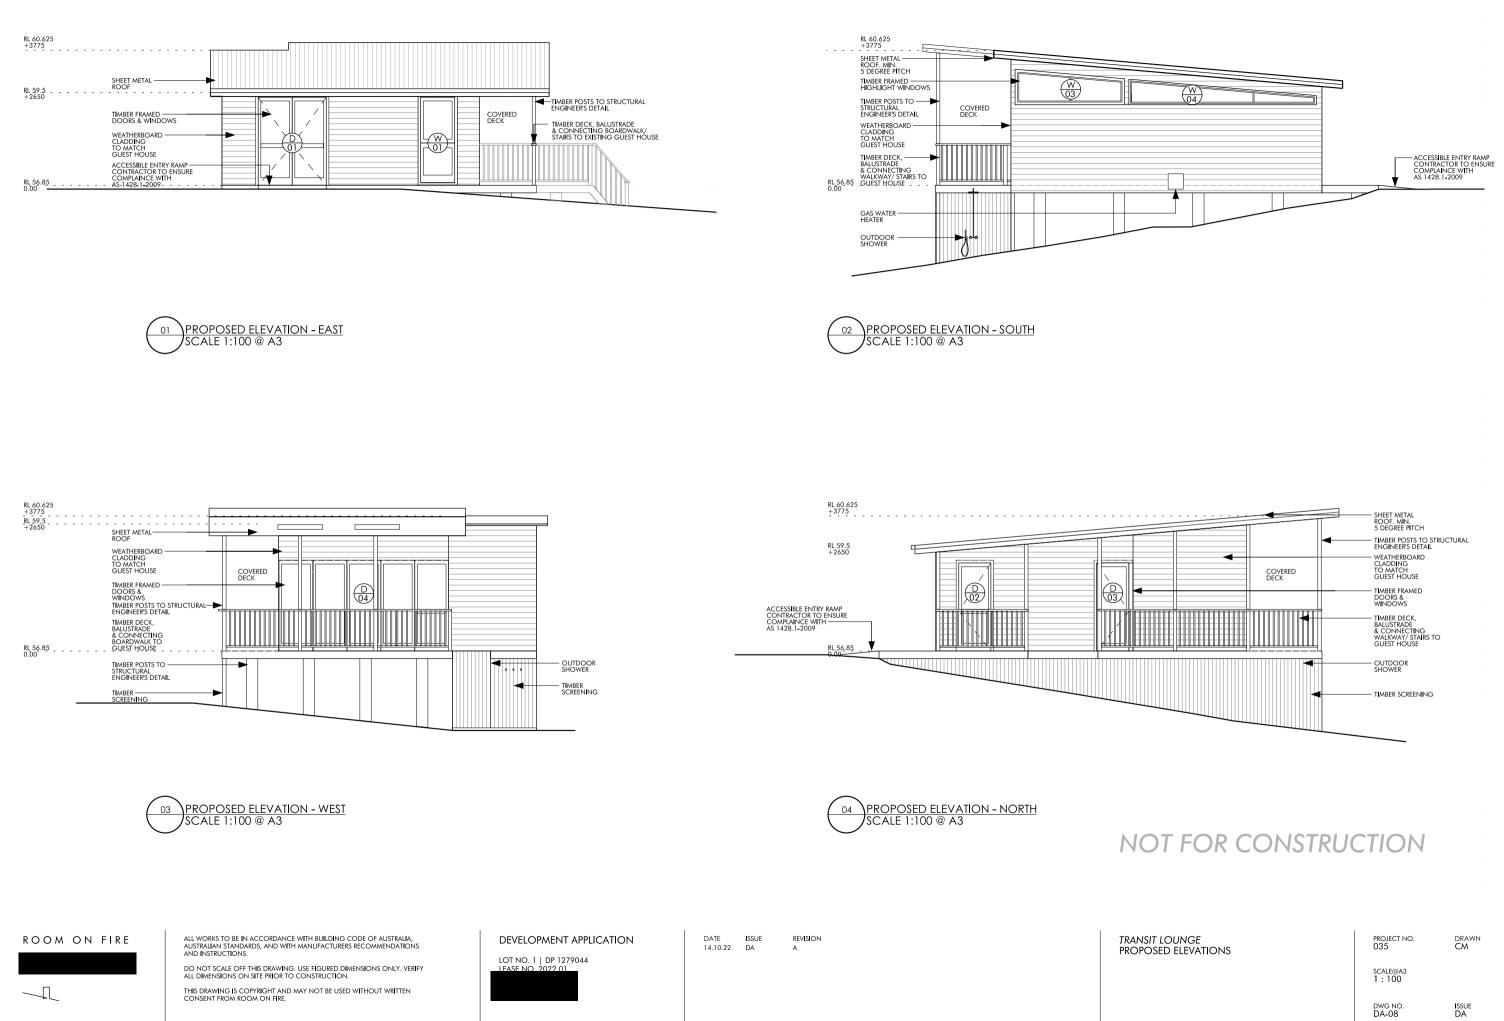

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DEVELOPMENT APPLICATION LOT NO. 1 | DP 1279044

DATE ISSU 14.10.22 DA REVISION ISSUE

TRANSIT LOUNGE PROPOSED SECTION




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project no. 035

DRAWN CM

issue DA

NOT FOR CONSTRUCTION

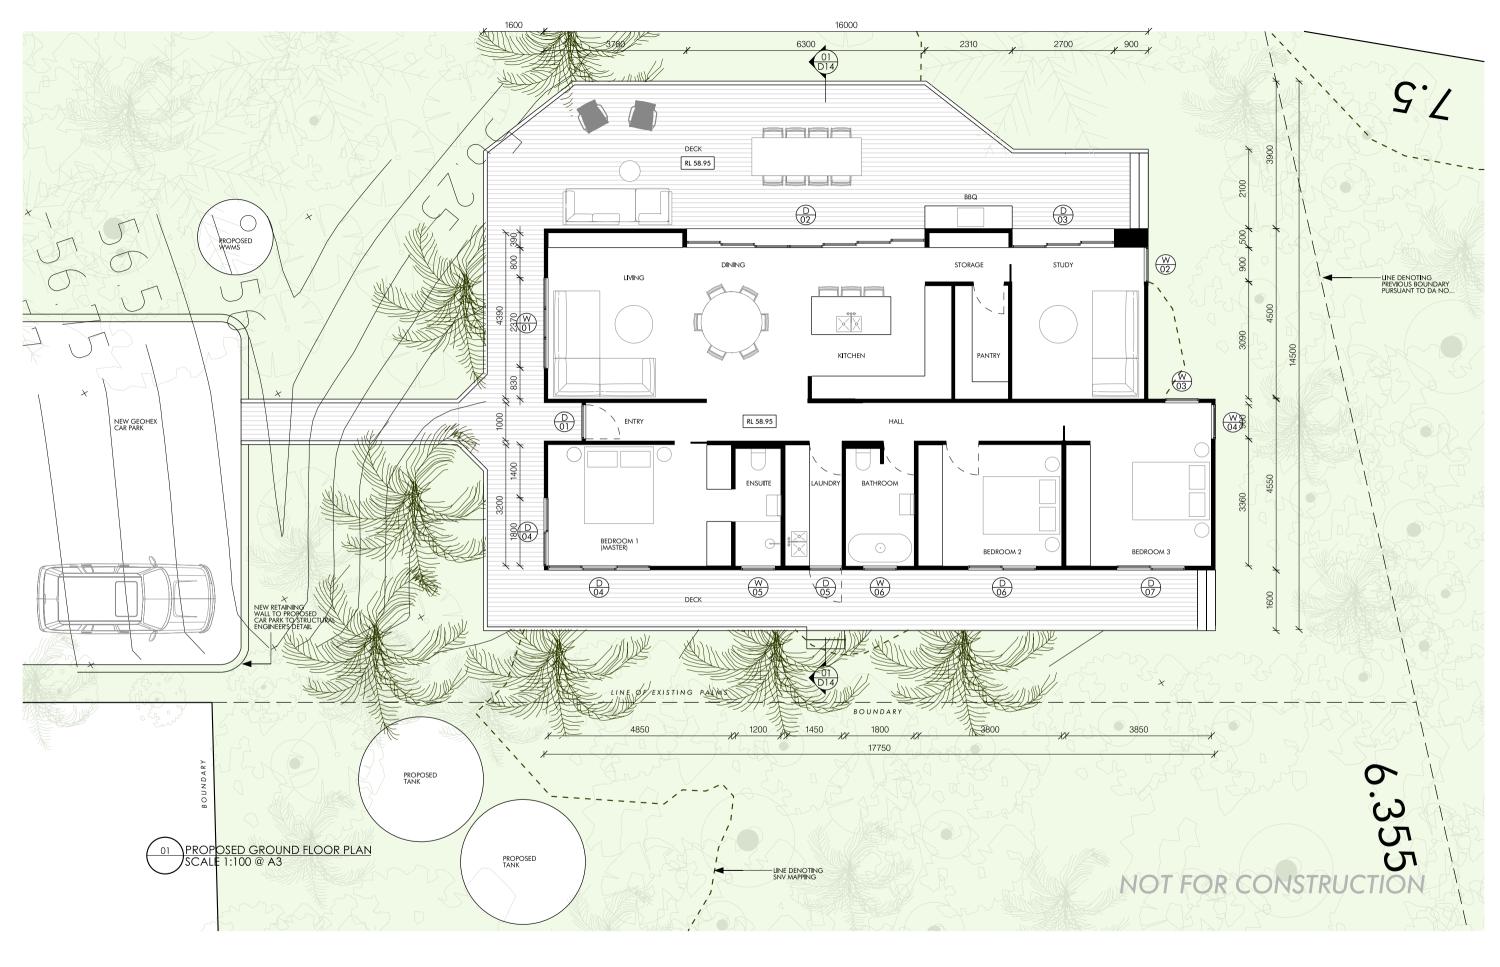

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ALL WORKS TO BE IN ACCORDANCE WITH BUILDING CODE OF AUSTRALIA, AUSTRALIAN STANDARDS, AND WITH MANUFACTURERS RECOMMENDATIONS AND INSTRUCTIONS.

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DEVELOPMENT APPLICATION LOT NO. 1 | DP 1279044 LEASE NO. 2022.01


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NEW DWELLING PROPOSED GROUND FLOOR PLAN

project no. 035 SCALE@A3 1:100 dwg no. DA-10

ISSUE DA

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DEVELOPMENT APPLICATION LOT NO. 1 | DP 1279044

DATE ISSUE 14.10.22 DA

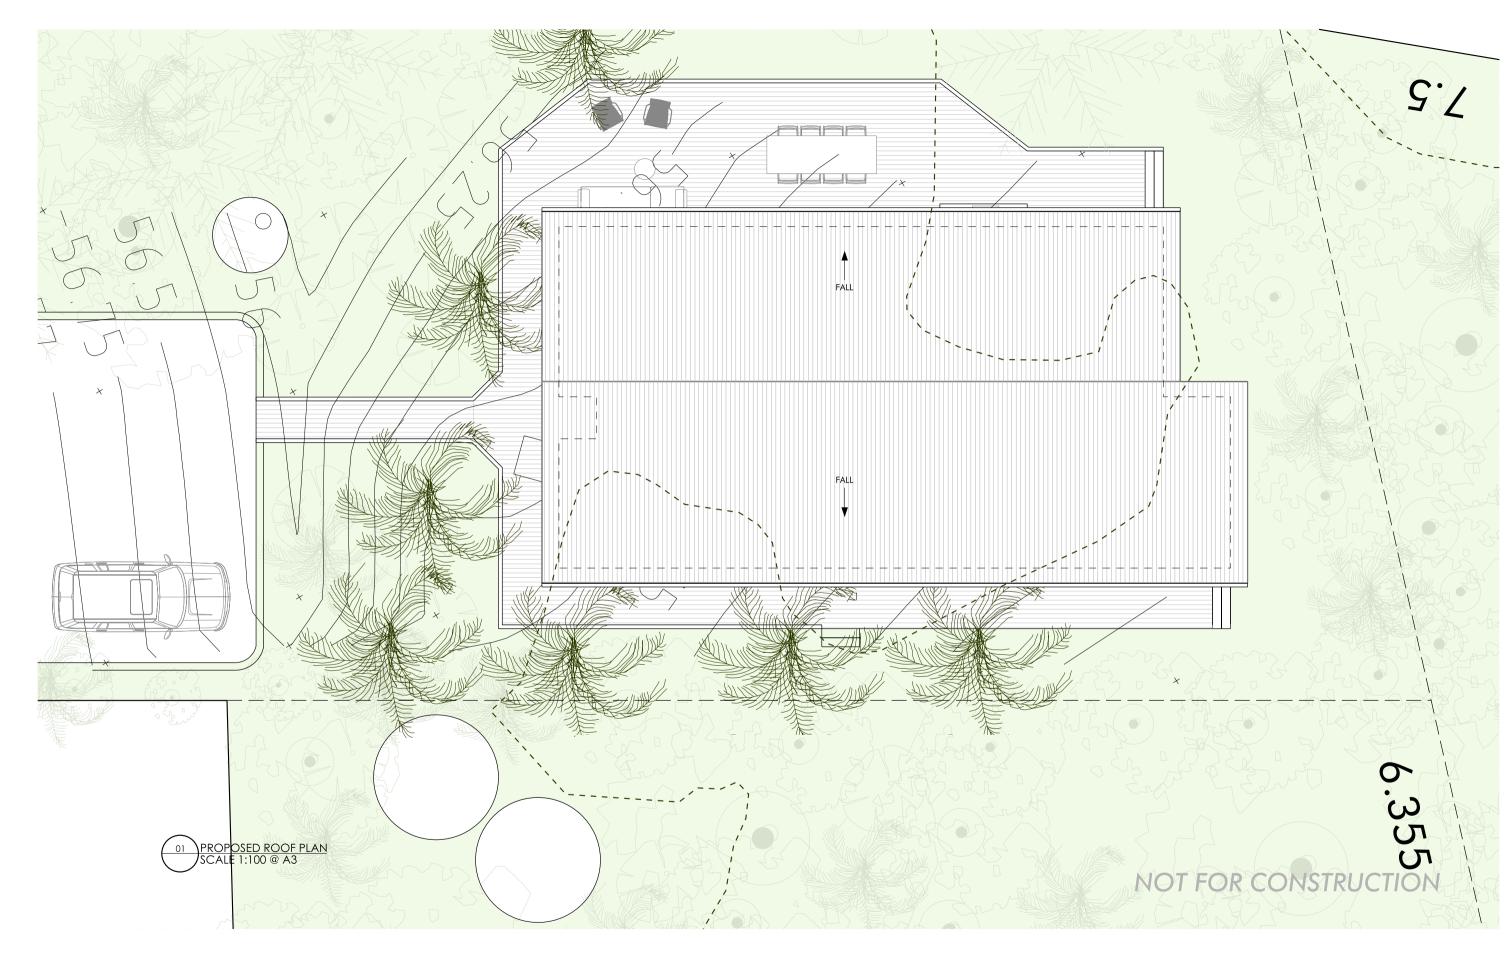REVISION





NEW DWELLING PROPOSED ROOF PLAN

project no. 035 SCALE@A3 1:100 dwg no. DA-11

issue DA

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 PROPOSED ELEVATION - NORTH SCALE 1:100 @ A3
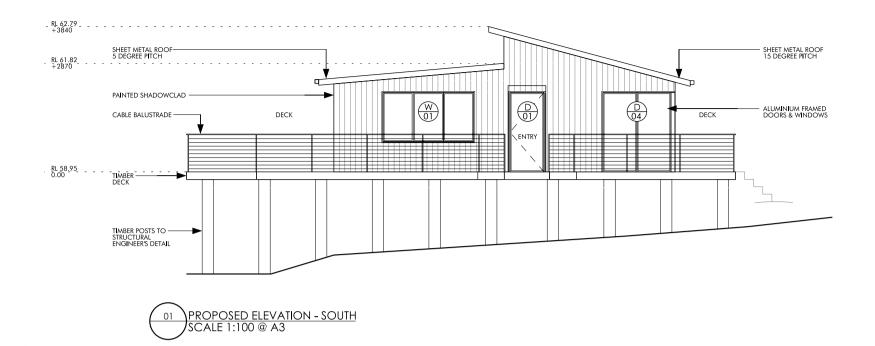
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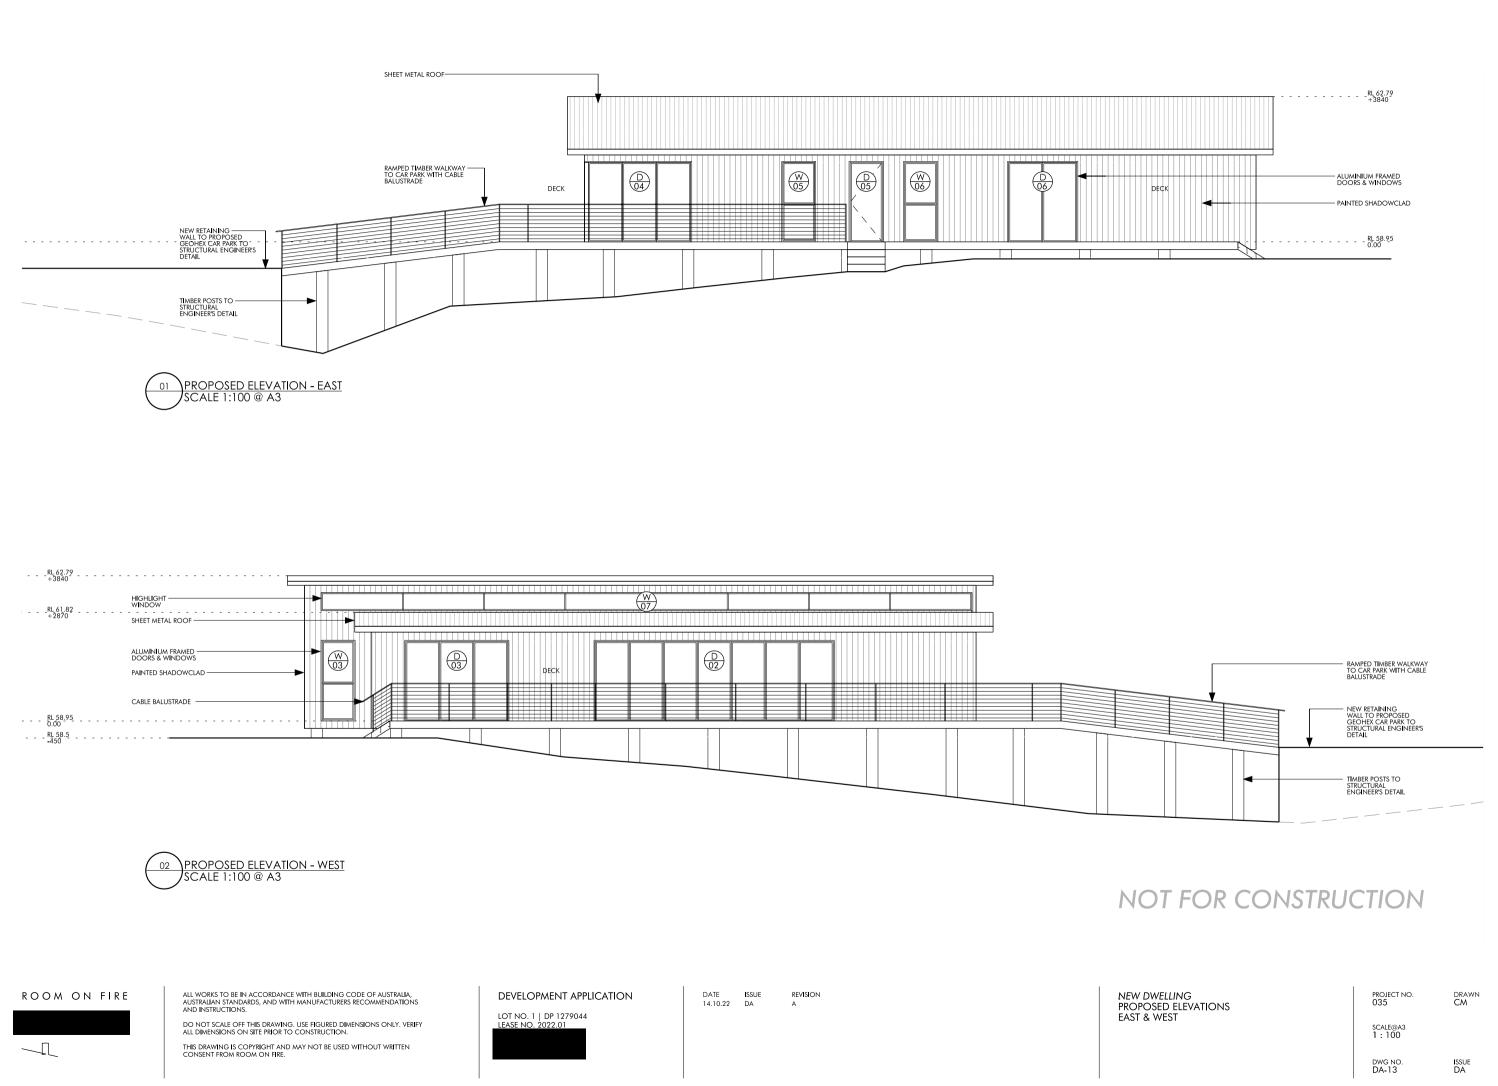
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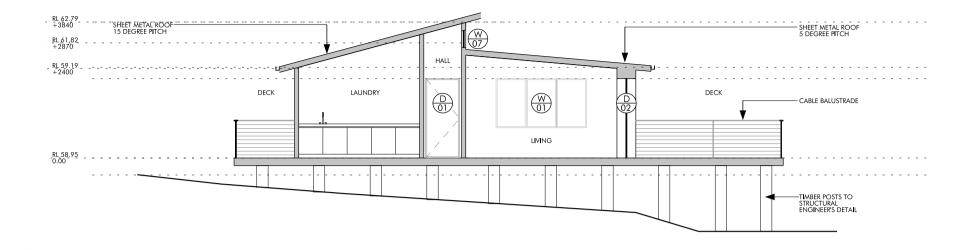
SCALE@A3 1 : 100 DWG NO. DA-12

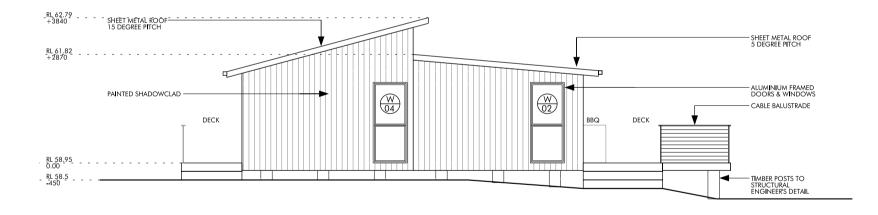project no. 035 DRAWN CM

ISSUE DA

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DEVELOPMENT APPLICATION LOT NO. 1 | DP 1279044 LEASE NO. 2022.01

DATE ISSU 14.10.22 DA REVISION ISSUE

NEW DWELLING PROPOSED SECTION

SCALE@A3 1:100 dwg no. DA-14

project no. 035

ISSUE DA

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NOT FOR CONSTRUCTION

BASIX[°]Certificate

Building Sustainability Index www.basix.nsw.gov.au

Single Dwelling

Certificate number: 1225039S_02

This certificate confirms that the proposed development will meet the NSW government's requirements for sustainability, if it is built in accordance with the commitments set out below. Terms used in this certificate, or in the commitments, have the meaning given by the document entitled "BASIX Definitions" dated 10/09/2020 published by the Department. This document is available at www.basix.nsw.gov.au

Secretary

Date of issue: Monday, 17 October 2022 To be valid, this certificate must be lodged within 3 months of the date of issue.



Planning, Industry & Environment

Project summary				
Project name				
Local Government Area	Lord Howe Island Board			
Plan type and plan number	deposited 1279044			
Lot no.	1			
Section no.	-			
Project type	separate dwelling house - secondary dwelling			
No. of bedrooms	3			
Project score				
Water	V 54 Target 40			
Thermal Comfort	V Pass Target Pass			
Energy	✓ 53 Target 50			

Certificate Prepared by

Name / Company Name:

ABN (if applicable): N/A

Description of project

Project address	
Project name	
and plan number	Deposited Plan 1279044
Lot no.	1
Section no.	-
Project type	
Project type	separate dwelling house - secondary dwelling
No. of bedrooms	3
Site details	
Site area (m ²)	6773
Roof area (m ²)	165
Conditioned floor area (m2)	145.0
Unconditioned floor area (m2)	9.0
Total area of garden and lawn (m2)	6000
Roof area (m2) of the existing dwelling	150
No. of bedrooms in the existing dwelling	3

Assessor details and thermal le	oads	
Assessor number	n/a	
Certificate number	n/a	
Climate zone	n/a	
Area adjusted cooling load (MJ/m².year)	n/a	
Area adjusted heating load (MJ/m ² .year)	n/a	
Ceiling fan in at least one bedroom	n/a	
Ceiling fan in at least one living room or other conditioned area	n/a	
Project score		
Water	V 54	Target 40
Thermal Comfort	V Pass	Target Pass
Energy	V 53	Target 50

Schedule of BASIX commitments

The commitments set out below regulate how the proposed development is to be carried out. It is a condition of any development consent granted, or complying development certificate issued, for the proposed development, that BASIX commitments be complied with.

Water Commitments	Show on DA plans	Show on CC/CDC plans & specs	Certifier check
Landscape		·	
The applicant must plant indigenous or low water use species of vegetation throughout 5500 square metres of the site.	~	~	
Fixtures			
The applicant must install showerheads with a minimum rating of 4 star (> 4.5 but <= 6 L/min plus spray force and/or coverage tests) in all showers in the development.		~	~
The applicant must install a toilet flushing system with a minimum rating of 6 star in each toilet in the development.		~	~
The applicant must install taps with a minimum rating of 6 star in the kitchen in the development.		~	
The applicant must install basin taps with a minimum rating of 6 star in each bathroom in the development.		~	
Alternative water			
Rainwater tank			
The applicant must install a rainwater tank of at least 20000 litres on the site. This rainwater tank must meet, and be installed in accordance with, the requirements of all applicable regulatory authorities.	~	~	~
The applicant must configure the rainwater tank to collect rain runoff from at least 150 square metres of the roof area of the development (excluding the area of the roof which drains to any stormwater tank or private dam).		~	~
The applicant must connect the rainwater tank to:			
all toilets in the development		~	~
 the cold water tap that supplies each clothes washer in the development 		~	~
 at least one outdoor tap in the development (Note: NSW Health does not recommend that rainwater be used for human consumption in areas with potable water supply.) 		~	~
all hot water systems in the development		~	~

ater Commitments	Show on DA plans	Show on CC/CDC plans & specs	Certifier check
all indoor cold water taps (not including taps that supply clothes washers) in the development		~	
	/		

Thermal Comfort Commitments	Show on DA plans	Show on CC/CDC plans & specs	Certifier check
General features			
The dwelling must not have more than 2 storeys.	~	~	~
The conditioned floor area of the dwelling must not exceed 300 square metres.	~	 	~
The dwelling must not contain open mezzanine area exceeding 25 square metres.	~	 	~
The dwelling must not contain third level habitable attic room.	~	 	~
Floor, walls and ceiling/roof			
The applicant must construct the floor(s), walls, and ceiling/roof of the dwelling in accordance with the specifications listed in the table below.	~	~	~

Construction	Additional insulation required (R-Value)	Other specifications
floor - suspended floor above open subfloor, framed	nil	
external wall - framed (weatherboard, fibre cement, metal clad)	2.80 (or 3.20 including construction)	
external wall - framed (weatherboard, fibre cement, metal clad)	2.80 (or 3.20 including construction)	
external wall - framed (weatherboard, fibre cement, metal clad)	2.80 (or 3.20 including construction)	
external wall - framed (weatherboard, fibre cement, metal clad)	2.80 (or 3.20 including construction)	
ceiling and roof - raked ceiling / pitched or skillion roof, framed	ceiling: 4.5 (down), roof: foil backed blanket (75 mm)	framed; light (solar absorptance < 0.475)

• Insulation specified in this Certificate must be installed in accordance with Part 3.12.1.1 of the Building Code of Australia.

Note • In some climate zones, insulation should be installed with due consideration of condensation and associated interaction with adjoining building materials.

Thermal Comfort Commitments	Show on DA plans	Show on CC/CDC plans & specs	Certifier check
Windows, glazed doors and skylights			
The applicant must install the windows, glazed doors and shading devices described in the table below, in accordance with the specifications listed in the table. Relevant overshadowing specifications must be satisfied for each window and glazed door.	~	~	~
The dwelling may have 1 skylight (<0.7 square metres) which is not listed in the table.	~	 	~
The following requirements must also be satisfied in relation to each window and glazed door:	~	 	~
• For the following glass and frame types, the certifier check can be performed by visual inspection.			~
- Aluminium single clear			
- Aluminium double (air) clear			
- Timber/uPVC/fibreglass single clear			
- Timber/uPVC/fibreglass double (air) clear			
• For other glass or frame types, each window and glazed door must be accompanied with certification showing a U value no greater than that listed and a Solar Heat Gain Coefficient (SHGC) within the range of those listed. Total system U values and SHGC must be calculated in accordance with National Fenestration Rating Council (NFRC) conditions. Frame and glass types shown in the table below are for reference only.			~
 Overshadowing buildings/vegetation must be of the height and distance from the centre and the base of the window and glazed door, as specified in the 'overshadowing' column. 	~	~	~

Window/glazed door no.	Maximum height (mm)	Maximum width (mm)	Туре	Shading Device (Dimension within 10%)	Overshadowing	
North facing						
W03	2100	900	U-value: 5.6, SHGC: 0.369 - 0.451 (aluminium, single, Lo-Tsol Low-e)	awning (adjustable) 450 mm, 200 mm above base of window or glazed door	>4 m high, 2-5 m away	
W02	1200	900	U-value: 5.1, SHGC: 0.324 - 0.396 (aluminium, double (argon), tint)	awning (adjustable) 450 mm, 250 mm above base of window or glazed door	>4 m high, <2 m away	
W01	900	900	U-value: 5.1, SHGC: 0.324 - 0.396 (aluminium, double (argon), tint)	eave 600 mm, 150 mm above head of window or glazed door	>4 m high, <2 m away	

Window/glazed door no.	Maximum height (mm)	Maximum width (mm)	Туре	Shading Device (Dimension within 10%)	Overshadowing
W04	1200	900	U-value: 5.6, SHGC: 0.369 - 0.451 (aluminium, single, Lo-Tsol Low-e)	awning (adjustable) 450 mm, 200 mm above base of window or glazed door	>4 m high, 2-5 m away
North-East facing					
W08	1200	900	U-value: 5.1, SHGC: 0.324 - 0.396 (aluminium, double (argon), tint)	awning (adjustable) 450 mm, 250 mm above base of window or glazed door	>4 m high, <2 m away
W07	2100	900	U-value: 5.1, SHGC: 0.324 - 0.396 (aluminium, double (argon), tint)	awning (adjustable) 450 mm, 250 mm above base of window or glazed door	>4 m high, <2 m away
W05	1200	900	U-value: 5.1, SHGC: 0.324 - 0.396 (aluminium, double (argon), tint)	awning (adjustable) 450 mm, 250 mm above base of window or glazed door	>4 m high, <2 m away
W06	1200	950	U-value: 5.1, SHGC: 0.324 - 0.396 (aluminium, double (argon), tint)	awning (adjustable) 450 mm, 250 mm above base of window or glazed door	>4 m high, <2 m away
South-West facing					
W12	2100	900	U-value: 5.1, SHGC: 0.324 - 0.396 (aluminium, double (argon), tint)	awning (adjustable) 450 mm, 250 mm above base of window or glazed door	not overshadowed
West facing					
W13	2100	1100	U-value: 5.1, SHGC: 0.324 - 0.396 (aluminium, double (argon), tint)	awning (adjustable) 450 mm, 250 mm above base of window or glazed door	not overshadowed
North-West facing			·		·
W14	2100	900	U-value: 5.1, SHGC: 0.324 - 0.396 (aluminium, double (argon), tint)	awning (adjustable) 450 mm, 250 mm above base of window or glazed door	not overshadowed

Energy Commitments	Show on DA plans	Show on CC/CDC plans & specs	Certifier check
Hot water			
The applicant must install the following hot water system in the development, or a system with a higher energy rating: gas instantaneous.	~	~	~
Cooling system			
The applicant must install the following cooling system, or a system with a higher energy rating, in at least 1 living area: ceiling fans; Energy rating: n/a		 	~
The applicant must install the following cooling system, or a system with a higher energy rating, in at least 1 bedroom: ceiling fans; Energy rating: n/a		 	~
Heating system			
The living areas must not incorporate any heating system, or any ducting which is designed to accommodate a heating system.		 	~
The bedrooms must not incorporate any heating system, or any ducting which is designed to accommodate a heating system.		 Image: A set of the set of the	~
Ventilation			
The applicant must install the following exhaust systems in the development:			
At least 1 Bathroom: individual fan, ducted to façade or roof; Operation control: manual switch on/off		 Image: A second s	~
Kitchen: individual fan, ducted to façade or roof; Operation control: manual switch on/off		 Image: A second s	~
Laundry: natural ventilation only, or no laundry; Operation control: n/a		 Image: A second s	~
Artificial lighting			
The applicant must ensure that the "primary type of artificial lighting" is fluorescent or light emitting diode (LED) lighting in each of the following rooms, and where the word "dedicated" appears, the fittings for those lights must only be capable of accepting fluorescent or light emitting diode (LED) lamps:			
 at least 4 of the bedrooms / study; dedicated 		~	~
 at least 2 of the living / dining rooms; dedicated 		✓	~
the kitchen; dedicated		~	~

Energy Commitments	Show on DA plans	Show on CC/CDC plans & specs	Certifier check
all bathrooms/toilets; dedicated		•	•
the laundry; dedicated		~	~
all hallways; dedicated		~	~
Natural lighting			
The applicant must install a window and/or skylight in the kitchen of the dwelling for natural lighting.	~	~	~
The applicant must install a window and/or skylight in 2 bathroom(s)/toilet(s) in the development for natural lighting.	~	 Image: A set of the set of the	~
Other			
The applicant must install a gas cooktop & gas oven in the kitchen of the dwelling.		~	
The applicant must construct each refrigerator space in the development so that it is "well ventilated", as defined in the BASIX definitions.		~	
The applicant must install a fixed outdoor clothes drying line as part of the development.		~	
The applicant must install a fixed indoor or sheltered clothes drying line as part of the development.		~	

Legend

In these commitments, "applicant" means the person carrying out the development.

Commitments identified with a v in the "Show on DA plans" column must be shown on the plans accompanying the development application for the proposed development (if a development application is to be lodged for the proposed development).

Commitments identified with a v in the "Show on CC/CDC plans and specs" column must be shown in the plans and specifications accompanying the application for a construction certificate / complying development certificate for the proposed development.

Commitments identified with a v in the "Certifier check" column must be certified by a certifying authority as having been fulfilled, before a final occupation certificate(either interim or final) for the development may be issued.

LORD HOWE ISLAND BOARD New Installation – Application for Supply

To be submitted no later than three months before supply is required.

A sketch plan of the portion showing all boundaries and adjacent portion umbers is to be submitted with this form. The plan should show the building where supply is required and indicate a preferred location of the external meter box.

Applicants should not incur any expenses in anticipation of receiving electricity until they hav ascertained that the supply can be made available and of the conditions under which the supply is given.

Printed copies of the Service and Installation Rules are available from the Board upon request. Each applicant is advised to be familiar with them prior to completing this form.

APPLICANT DETAILS Name of Applicant/s: Chad Wilson Postal Phone // ///-INSTALLATION Lease No.: 2022.01 Portion No.: .1. 25 LIGHTS Number of Points 38 Total Rating (Watts) Number of Double POWER Number of Single GPO's 30 GPO's Number **SOLAR WATER** N/A **Total Rating (Watts** Capacity of each Heater **HEATERS** (Litres)

OTHER APARATUS PERMANENTLY CONNECTED:

Number

Phase (Single/Three

Proposed domestic dwelling.

Lord Howe Island Board

MOTORS

New or Altered Electricity Meter

N/A

....

Total Rating (Watts)

LORD HOWE ISLAND BOARD New Installation – Application for Supply

To be submitted no later than three months before supply is required.

A sketch plan of the portion showing all boundaries and adjacent portion umbers is to be submitted with this form. The plan should show the building where supply is required and indicate a preferred location of the external meter box.

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TALLATION Portion No See No.: 2022.01 Portion No Additional load. Additional load. LIGHTS Number of Points 58 POWER Number of Single GPO's SOLAR WATER Number HEATERS Capacity of each Heater (Litres) Image: Capacity of each Heater	Date:30/05/2022	
TALLATION Portion No See No.: 2022.01 Portion No Additional load. Additional load. LIGHTS Number of Points 58 POWER Number of Single GPO's SOLAR WATER Number HEATERS Number Capacity of each Heater [Litres])ate:	
TALLATION Portion No se No.: 2022.01 Portion No Additional load. Additional load. LIGHTS Number of Points 58 POWER Number of Single GPO's SOLAR WATER Number HEATERS Number Lights Lights Lights Number of Single GPO's	Date:30/05/2022	
STALLATION Portion No se No.: 2022.01 Portion No Additional load. Additional load. LIGHTS Number of Points 58 POWER Number of Single GPO's Solar water HEATERS Number Capacity of each Heater (Litres) Image: Capacity of each Heater Image: Capacity of each Heater	Date:30/05/2022	
TALLATION Portion No se No.: 2022.01 Portion No Additional load. Additional load. LIGHTS Number of Points 58 POWER Number of Single GPO's Image: Capacity of each Heater (Litres)		
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POWER Number of Single GPO's SOLAR WATER HEATERS Number Capacity of each Heater (Litres) Image: Capacity of each Heater	Total Rating (Watts)	25
SOLAR WATER Number HEATERS Capacity of each Heater (Litres) (Litres)		
SOLAR WATER HEATERS (Litres)	Number of Double GPO's	26
HEATERS Capacity of each Heater (Litres)		N/A
	Total Rating (Watts	
Number		N/A
MOTORS Phase (Single/Three	Total Rating (Watts)	
THER APARATUS PERMANENTLY CONNECTED:		
urrent household Load remains. Minus Solahart.		
Propose to commercial of		

Lord Howe Island Board Onsite Wastewater Management Systems Checklist for Applicants to Streamline Development Consent

The installation of onsite wastewater management systems on Lord Howe Island requires development consent as they are not listed as exempt development under the LHI Local Environmental Plan 2010.

A streamlined assessment process has been put in place for minor developments that, in the opinion of the Board, are of minimal social and environmental impact.

This checklist has been developed to ensure applicants provide all necessary information to support their application. If your answers match those required for all of the 3 stages in the form, then the application will be deemed to be minor and can be determined by the CEO under delegated authority. Applications that fall outside of this will need to be considered under the standard development application process.

The Board will accept Owner Consent (OC) and Development Application (DA) information as one (1) submission, however the DA will not be able to be lodged until the OC is approved. You will receive written advice when the OC is approved, at which time you will need to attend the Board offices and pay the DA lodgement fee. Subject to the provision of the adequate information, Owner Consent will be processed in 5 working days and Development Application within 15 working days.

Pre-Lodgement Meeting

Have you had a pre-lodgement meeting with LHIB staff?	🗴 Yes 🗌 No
If yes, have you incorporated comments and suggestions into your submission?	🗴 Yes 🗌 No

<u>Owner Consent Requirements – Please include information below in the application</u>

Stage	Forms, Plans				
1	Have you completed an OC application form (incl signatures from all lessees)?	🗴 Yes 🗌 No			
	Have you provided a scaled site plan showing the lease, system and disposal areas?	🗴 Yes 🗌 No			
All ans	wers to Stage 1 must be 'Yes' before proceeding to Stage 2.				
2	Environment & Heritage				
	Is the treatment or disposal area mapped as containing significant native vegetation?	🔀 Yes 🗌 No			
	Is construction access to the area for the system through significant native vegetation?	🗌 Yes 🗶 No			
	If a heritage item (as per Schedule 2 of the LHI Local Environmental Plan 2010) is located on the land, then is the system located within 10m of the Heritage item?	🗌 Yes 🔀 No			
	Is the treatment or disposal area mapped as flood hazard? The LHIB holds flood mapping GIS layers.	🗌 Yes 🔀 No			
	Is the disposal area an insufficient size for the soil type? Note disposal areas should not be within areas of SNV, heritage and flooding.	🗌 Yes 🔀 No			
	System				
	Is the application for a commercial wastewater management system?	🔀 Yes 🗌 No			
If all St	If all Stage 2 answers are 'No', and you wish to lodge a DA at this stage, proceed to Stage 3.				
	If all Stage 2 answers are 'No', and you wish to only lodge Owner Consent (OC) at this stage, the OC application				
can be determined by the CEO.					

If any answer to Stage 2 answer is 'Yes', then the application will be considered under the standard DA process. Please contact LHIB to discuss.

Development Application Requirements – Please include information below in the application

Stage	Forms, Plans	
3	Have you completed a Development Application form?	🗙 Yes 🗌 No
	Have you provided a site plan & soil plan (including plans from the supplier, irrigation area, lease boundaries, vegetation, underground pipes,pumps,tanks,buffer distances)?	🗙 Yes 🗌 No
	Is the system from the list of LHIB preferred suppliers–Truewater, Rootzone, Earthsafe or Supertreat?	🗙 Yes 🗌 No
	Is the system being installed in full compliance with the NSW Health accreditation?	💢 Yes 🗌 No


If the system is not from a preferred supplier, is it accredited with NSW Health?	🗌 Yes 🗌 No 💢 NA
Design – to be completed by your supplier	
Does the proposal meet the LHIB Onsite Wastewater Management Strategy?	🔀 Yes 🗌 No
Does the design meet the domestic performance standards in Table 5.1.1?	💢 Yes 🗌 No
Has your supplier calculated the predicted daily wastewater load on the system & is this included in your DA?	🔀 Yes 🗌 No
Has the soil type & presence of any subsoil barriers on the site been checked?	🔀 Yes 🗌 No
Has your supplier calculated the water & nutrient balance for your site & is it in the DA?	🗌 Yes 🔀 No
If your system has a pump to move wastewater, has your supplier assessed the pumping heights against the pump capacity & included this in your DA?	🗌 Yes 🗌 No 🔀 NA
Where a wastewater pipe goes under a road or vehicle track, has the supplier ensured it will be buried at least 500mm?	🗌 Yes 🗌 No 🔀 NA
Has the irrigation system for effluent disposal being specifically designed for your property and taken consideration of your specific soil types?	🔀 Yes 🗌 No
Does the irrigation system include a flushing point?	🗙 Yes 🗌 No
Is there adequate disposal area for the treated effluent?	💢 Yes 🗌 No
Does the proposed system only use sub-soil or dripper irrigation?	🔀 Yes 🗌 No
Does the proposed system include a visual alarm which is visible on approach to the dwelling and is it shown on the plans?	🔀 Yes 🗌 No
Site Arrangements	
Is the treatment area and disposal area on the same lease? If No, you will need a written agreement with the other leaseholder(s) permitting the disposal of effluent.	🔀 Yes 🗌 No
Is the disposal area more than 20m from all neighbouring property boundaries? If No, you will need a written agreement with neighbouring leaseholder(s) incl in application.	🗌 Yes 🔀 No
Is the system or disposal area more than 100m from permanent surface waters?	🗌 Yes 🔀 No
Is the system & disposal area more than 50m from a well\bore used for human supply?	
Is the system or disposal area more than 20m from non-permanent water ways (eg. drainage gullies or channels)?	🕅 Yes 🗌 No
For surface irrigation, is the irrigation area not used for food production?	
Is the irrigation area unaffected by flooding? The LHIB holds flood mapping GIS layers.	
Is the irrigation area unaffected by stormwater from above?	X Yes No
Is the property more than 1,500sqm in size?	🕅 Yes 🗌 No
Based on 2 people for the 1 st bedroom and 1 person\ bedroom for remaining bedrooms in the dwelling, are there less than 10 people being serviced by the proposed system?	🔀 Yes 🗌 No
 Have you provided: Statement of warranty and service life; Quality Assurance Certification; Installation Manual; 	🗙 Yes 🗌 No
Service Manual for use by service technicians,Household Operators Manual	
 Household Operators Manual Service Report Form suitable for use by service technicians; 	
 Engineering Drawings on A3 format & system specifications; 	
A4 site plans showing location of system and associated irrigation areas;	
 Accreditation from NSW Health (if not from an LHIB preferred supplier); and Service agreement with the agent who will maintain the systems. 	
If Stage 3 answers are 'Yes', the application can be determined by the CEO. If any Stage 3 a application will be considered under the standard DA process. Please contact LHIB to discu	
Office use only Date received:	
Approved by:	
Signature: Date approved:	



FujiClean ACE 3000



Advanced Secondary Effluent Quality <10 Mg/L BOD 5 < 10 Mg/L Suspended solids 3000 LPD 20 EP @150 LPD

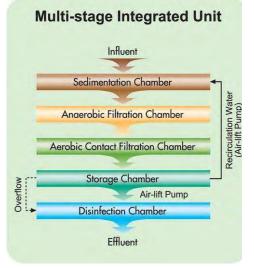

Compact and Efficient

This Advanced, Compact, and Efficient unit has been specifically designed using leading Japanese engineering technologies to achieve maximum operational efficiency. The ACE3000 is a whole household treatment plant.

Due to its light weight and compact design allowing for 3000 L per 24 hours, the Fuji Clean ACE system is extremely easy to transport and install. Overall weight of 550 KG makes for an easier delivery and installation.

Commercial Adaptability


The ACE system can easily be customised according to site requirements. The ACE systems can be installed easily at various types of sites (not only domestic) which are not connected to municipal sewage supply; including mining sites, caravan parks, resorts, remote islands, service stations, schools, tourist cabins, community housing and other similar projects producing up to 3000 LPD of influent.

Fuji Clean Australia PTY LTD

With over 60 years of experience, Fuji Clean is one of the world's leading manufacturers of high efficiency wastewater treatment systems with over 2 million systems (both domestic and commercial) installed around the world.

Volume (L) Dimensions (mm)			
Sedimentation Chamber	3,169	Max. Width	1,84
naerobic Filtration Chamber	3,177	Max. Length	3,88
erobic Contact Filtration Chamber	1,431	Max. Height	2,2
larification Chamber	703	Max. Height (with 150mmH risers)	2,3
isinfection Chamber	44	Max. Height (with 300mmH risers)	2,5
otal Volume	8,524	Inlet Invert	5
/eight (kg)	550	Inlet Invert (with 150mmH /300mmH risers)	650 / 8
		Outlet Invert	6
		Outlet Invert (with 150mmH /300mmH risers)	750 / 9
			Dia. 1
			Dia. 1

Pump out chamber with emergency effluent storage required. Not shown here. 2000 ltrs.

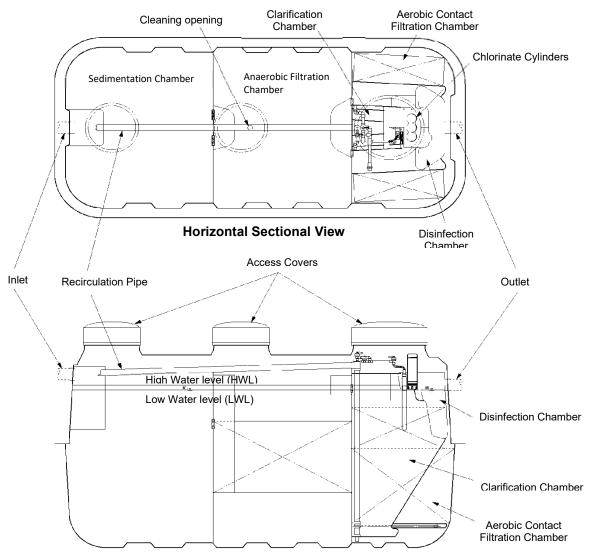

Vertical Sectional View

Fuji Clean Australia

With over 60 years of experience, Fuji Clean is one of the world's leading manufacturers of high efficiency wastewater treatment systems with over 2 million systems (both domestic and commercial) installed around the world.



SOLAR AND POWER USAGE

FujiClean ACE 3000 - Domestic / Commercial AWTS

The FujiClean ACE 3000 AWTS is 100% compatible with homes using a stand-alone solar power system. For the system to operate correctly it requires:

- A stable and continuous connection to a 10 amp 240V AC +/- 5% maximum and a frequency of 50Hz.
- A suitable inverter is to be used.

NOTE: Must allow for the ACE3000 energy requirements.

- The power supply to have sufficient capacity to run all components without the voltage supply dropping when the load is applied.
- A contingency plan if the house experiences long periods without power.

NOTE: like any AWTS, prolonged periods without power will cause the bacteria to die off and result in system failure. A standard 20 person household uses an average of 2500 L to 3000 L per day (24 hrs)

FujiSub 4520 submersible pump with 20m head has a flowrate of 45L/min.

An average pump cycle for the FujiClean ACE 3000 is 20 minutes. Therefore with average loading, the FujiSub 4520 will activate and cycle 2-3 times per day for 20 minutes. Used for subsurface irrigation disposal. Averages may differ per household

FujiSub 756 submersible pump with 8m head has a flowrate of 25L/min.


An average pump cycle for the FujiClean ACE 3000 is 36 minutes. Therefore with average loading, the FujiSub 756 will activate and cycle 2-3 times per day. Used for surface irrigation disposal. Averages may differ per household

MAC 200RII Air Blower runs 24 hours/day and provides 200L of aeration per minute.

Electrical Component	Startup Amps	Run Wattage / Amps	Daily Usage max
MKII Treatment Monitor Unit	3 W	3 W	24 hours
MAC200 RII Air Blower	Less than 1 A	140 Watts 0.53 A	24 hours
FujiSub 756 Submersible Pump	Less than 3.0 amps	550 watts 2.1 A	2 hours
FujiSub 4520 Submersible Pump	Less than 5.5 amps instant	800 watts 3.2 A	1.2 hours
FujiSub 5025 Submersible Pump	Less than 7.0 amps	1000 watts 4.0 A	1.0 hours
50 LPM at a 25 mtr head			

NOTE: Only one type of submersible pump is required. If you require any further information on the FujiClean ACE 3000 energy requirements please contact FujiClean Australia Head Office on <u>1300 733 619</u> or <u>info@fujiclean.com.au</u>



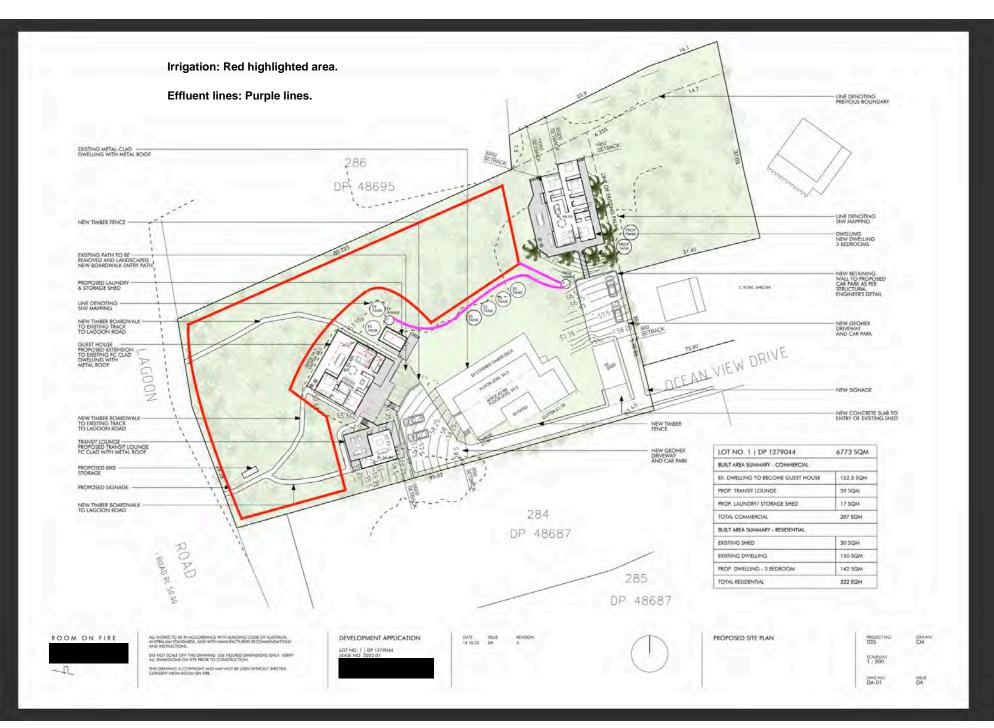

P/L No. 2022.01

System Install Overview

It is proposed to install a NSW Health accredited FujiClean ACE3000 Aerated Wastewater Treatment System to service the wastewater needs of the property.

The FujiClean system will be installed next to the existing garage and banana plantation. The system comes with its own visual alarm to alert of system malfunction such as high water, aeration pump failure etc.

The existing 'enviro-cycle by the proposed commercial building will become a 'catch tank' and be pumped to the FujiClean System for treatment. Waste water from dwellings 1 & 2 will travel directly to the new system via gravity. All pipework connecting this 'catch tank' to the FujiClean system, located within areas mapped as Significant Native Vegetation (SNV), will be laid on the surface.

The treated effluent will be disinfected with chlorine prior to discharge to the irrigation field to the West of the property (see attached site plan). The irrigation field will have small diameter (12mm) drip pipe laid in grid pattern. Due to the large volume of effluent, the irrigation will be split in to 4 fields using a rotating sequential valve to distribute it evenly across the total area All pipework connecting the FujiClean system to the irrigation field, located within areas mapped as SNV, will be laid on the surface.

The daily hydraulic load of effluent to be treated is 2280lt. This is calculated by the following flow rates:

Source	Number	Lt/day	Total Lt/day
Dwelling 1	4 x bed = 5 EP	120	600
Dwelling 2	3 x bed = 4EP	120	480
Proposed Tourist Accom	8 x pax	150	1200
Total Daily Flow			2280

The proposed effluent irrigation area is to be situated on Lot 1 of P/L No. 2021.01. The soil type on Lot 1 is basalt. A soil sample will be provided to the Board for confirmation. The area required for the effluent irrigation with this soil type is 2160m² - see attached Water and Nutrient Balance calculations provided by the Lord Howe Island Board.

Letter of Agreement

LETTER OF AGREEMENT (the "Document") made as of this 3^{++} day of Movember . 2022 (the "Execution Date").

BETWEEN:

(individually the "Party" and collectively the "Parties")

Agreement Description

- 1. The subject of this Agreement is described as follows:
 - Waste water irrigation

Additional Terms

2. This is an agreement to allow Chad Wilson run waste water irrigation within 20 m of the Boundary Lot 286 owned by

This Document accurately reflects the understanding between the Parties, signed on this 3/4 day of November, 2022



Letter of Agreement

LETTER OF AGREEMENT (the "Document") made as of this 30^{th} day of October , 2022 (the "Execution Date")?

BETWEEN:

(individually the "Party" and collectively the "Parties",

Agreement Description

- 1. The subject of this Agreement is described as follows:
 - Waste water irrigation

Additional Terms

2. This is an agreement to allow Chad Wilson run waste water irrigation within 20 m of the Boundary Lot 284 owned by

This Document accurately reflects the understanding between the Parties, signed on this 30^{+h} day of October, 2022.

